

Render view from June 2023

PROJECT TEAM APN MAP VICINITY MAP

PROPOSED PROJECT

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RESIDENTIAL APARTMENT PROPOSAL

940 WILLOW STREET

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COVER

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ARCHITECTUR

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Project:

940 Willow Street

Mixed Use Proposal

Consultant

REFERENCE FILE # PRE23-089 SUBMITTED ON JUNE 12, 2023

H23-030 SITE DEVELOPMENT PERMIT

Revision

	Date
E DEVELOPMENT	10.05.2023
VISION 1	12.01.2023



Sheet Information

Issue Date	12/01/2023
Job Number	Project Number
Drawn	Author
Checked	Checker
Approved	Designer
Scale	1" = 300'-0"
Sheet Title	

COVER SHEET

000-IDX

REFERENCE FILE # PRE23-089 SUBMITTED ON JUNE 12 PROJECT INFORMATION (SHOWN FOR REFERENCE ONLY)

SITE LOCATION	SITE AREA	APN#
940 WILLOW STREET SAN JOSE CA, 95125	0.8 ACRES	429-03-070, 429-03-072
ZONING:	COMMUNITY NEIGH	BORHOOD (CN)
MINIMUM SETBACK		
FRONT	10' NONE	
SIDE, INTERIOR REAR, CORNER	NONE	
REAR, INTERIOR	NONE	
MAXIMUM HEIGHT	50'	
GENERAL PLAN	NEIGHBORHOOD / (COMMUNITY COMMERCIAL (NCC)
NUMBER OF STORIES ALLOWED	1 TO 5 STORIES	
DENSITY	F.A.R UP TO 3.5	

PROPOSED PROJECT DATA (CA GOV CODE 65589.5(D)(5) "BUILDER'S REMEDY" UNIT BREAK UP PER FLOOR	_							
CA GOV CODE \$65596.5(D)(S) 'BULIDER'S REMEDY' THIS PROJECT IS LOCATED AT 940 WILLOW STREET. AT THE CORNER OF KOTENBERG AVENUE AND WILLOW STREET. IT CONSISTS OF 156 UNITS UTILIZING THE STATE DENSITY BONUS. THE BUILDING IS SEVEN STORIES WITH FIVE LEVELS OF TYPE 1A. THERE ARE '35 PARKING SPACES. CONSTRUCTION TYPE	F	PROPOSED PROJECT DATA	(CA GOV CODE	65589.5(D)(5) "B	UILDER'S REME	DY"	UNIT BREAK U	JP PER FLOOR
STUDIO 10 10 10 10 10 10 10 1	C/ AN	A GOV CODE 65589.5(D)(5) "BUILDER'S RE ND WILLOW STREET. IT CONSISTS OF 120	6 UNITS UTILIZING THE	STATE DENSITY BONUS			3 BED TH TOTAL	
NUMBER OF STORIES PROPOSED 7			TYPE 1A (GROUND FI	LOOR, 2ND FLOOR)	RS OF CONCRETE)		1 BED 2 BEDS	10 5
PROPOSED HEIGHT 75 STUDIO 10 18ED 10 18ED 10 10 18ED 11 18ED 11 18ED 11 18ED 11 18ED 11 18ED 11 18ED 10 10 18ED 10 10 10 10 10 10 10 1	N	UMBER OF STORIES PROPOSED	7				15/51	
RESIDENTIAL R-2 PARKING S-2 PARKING S-2 PARKING S-2 PARKING S-2 PARKING S-2 PARKING MERCANTILE M PROPOSED DENSITY FAR 5.26 STUDIO 10 18ED 11 18ED 11 18ED 11 18ED 15 10 18ED 11 18ED 10 18ED 11 18ED 10 10 18ED 10 10 18ED 10 10 10 10 10 10 10 1	<u>Pl</u>	ROPOSED HEIGHT	75'					10
PROPOSED DENSITY	<u>O</u>	CCUPANCY TYPE	PARKING	S-2			1 BED 2 BEDS	10 5
DENSITY 157.5 D.U./ACRE 157.5 D.U./ACRE 10 10 18 11 18 11 18 15 15 15							LEVEL 5	
PROPOSED NUMBER OF UNITS	<u>Pl</u>	ROPOSED DENSITY					1 BED	11
THREE BED TH. 4 126 UNITS STUDIO 11 1 1 1 1 1 1 1 1	<u>Pl</u>	ROPOSED NUMBER OF UNITS	ONE BEDROOM	50				
PARKING PROVIDED GROUND FLOOR SECOND FLOOR SECOND FLOOR TOTAL 135 SPACES PROV'D (100%) GROUND FLOOR SECOND FLOOR TOTAL 135 SPACES PROV'D (100%) TOTAL TOTAL							LEVEL 6	
SECOND FLOOR			TOTAL	126 UNITS			1 BED 2 BEDS	10 2
(100%) (100%) (100%) 1 BED 10 2 BEDS 2 TOTAL 123 UNITS TOTAL NUMBER 126 UNITS OF UNITS	<u>P</u> /	ARKING PROVIDED					LEVEL 7	
OF LINITS			TOTAL				1 BED 2 BEDS TOTAL	10 2 23 UNITS

R	UNIT	MIX DIAGRA	AM	SITE DATA			
	UNIT MIX *STUDIO *1BED *2BED *3BED TOWNHOME		SITE AREA (SF) SITE AREA (ACRES) O.8 AC LOT COVERAGE (SF) LOT COVERAGE (%) FAR S.26 DENSITY (D.U./ACRE) NET RESIDENTIAL LEASABLE (SF) NET RETAIL LEASABLE (SF) GARAGE AREA 5.6, 169 SF APPLICABLE CODES & STANDARDS 2022 CALIFORNIA BUILDING CODE (CBC) 2022 CALIFORNIA MECHANICAL CODE (CMC) 2022 CALIFORNIA PLUMBING CODE (CPC) 2022 CALIFORNIA ELECTRICAL CODE (CEC) 2022 CALIFORNIA FIRE CODE (CFC) 2022 CALIFORNIA FIRE CODE (CFC) 2022 CALIFORNIA GREEN BUILDING STANDARD CODE 2022 CALIFORNIA GREEN BUILDING STANDARD CODE 2022 CALIFORNIA ENERGY CODE (CENC)				
	AREA BRE	EAK UP					
	LEVELS	GARAGE	RETAIL	CIRCULATION	RESIDENTIAL (NET)	AMENIT
	LEVEL 1	27, 732 SF	1, 799 SF		3, 378 SF		
	LEVEL 2	28, 437 SF			3, 378 SF		
	LEVEL 3			2, 773 SF	18, 250 SF		12, 768 S
	LEVEL 4			2, 773 SF	18, 250 SF		
	LEVEL 5			2, 773 SF	18, 948 SF		
						1	

1, 799 SF

LEVEL 6

LEVEL 7

UNIT BREAK UP PER FLOOR

4 4 UNITS

24 UNITS

25 UNITS

26 UNITS

11

24 UNITS

23 UNITS

126 UNITS 100%

LESS THAN 20% CHANGES

56, 169 SF

UNIT MIX DIAGRAM

UNIT MIX

■ STUDIO ■ 1 BED ■ 2 BED ■ 3 BED TOWNHOME

96 N. Third Street, Suite 110, San Jose, CA, 95112 T. 408.816.2000 www.studiocurrent.com 940 Willow Street Mixed Use Proposal Consultant STANDARD CODE (CGBSC) **AMENITY**

12, 768 SF

2, 843 SF

15, 611 SF

183, 741 SF

(100%)

16, 272 SF

16, 272 SF

94, 747 SF

PROJECT TOTAL:

34,797 SF

32,476 SF

45'808 SF

157.5 D.U./ACRE

LESS THAN 20% CHANGES

96.81%

5.26

0.8 AC

2, 548 SF

2, 548 SF

13, 415 SF

SITE DATA

SITE AREA (SF)

GARAGE AREA

SITE AREA (ACRES)

LOT COVERAGE (SF)

LOT COVERAGE (%)

DENSITY (D.U./ACRE)

NET RETAIL LEASABLE (SF)

NET RESIDENTIAL LEASABLE (SF) 78,440 SF

THIS PROJECT WILL BE IN COMPLIANCE WITH THE SAN JOSE REACH CODE

APPLICABLE CODES & STANDARDS

STUDIO

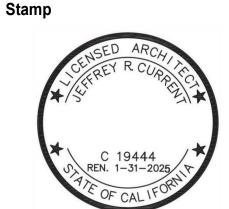
CURRENT

REFERENCE FILE # PRE23-089 SUBMITTED ON JUNE 12, 2023

H23-030 SITE DEVELOPMENT **PERMIT**

Revision

No	Date
SITE DEVELOPMENT	10.05.2023
REVISION 1	12.01.2023



Sheet	Information	

ssue Date	12/01/2023
Job Number	Project Number
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Checked	Checker
Approved	Designer
Scale	
Shoot Title	

TITLE SHEET

CURRENT SUBMISSION (CHANGES SHOWN IN BLUE TEXT)


CITY OF SAN JOSE CURRENT ZONING /GENERAL PLAN STANDARDS


SITE LOCATION 940 WILLOW STREET SAN JOSE CA, 95125	SITE AREA 0.8 ACRES	APN # 429-03-070, 429-03-072
ZONING:	COMMUNITY NEIGHBORH	IOOD (CN)
MINIMUM SETBACK		
FRONT SIDE, INTERIOR REAR, CORNER REAR, INTERIOR	10' NONE NONE NONE	
MAXIMUM HEIGHT	50'	
GENERAL PLAN	NEIGHBORHOOD / COMM	UNITY COMMERCIAL (NCC)
NUMBER OF STORIES ALLOWED	1 TO 5 STORIES	
DENSITY	F.A.R UP TO 3.5	


PROJECT DESCRIPTION				LEVEL 1 & 2	
CA GOV CODE 65589.5(D)(5) "BUILDER'S RI	EMEDY": THIS PROJEC	CT IS LOCATED AT 940 WILLO	OW STREET, AT THE CORNER OF		
KOTENBERG AVENUE AND WILLOW STRE	ET. IT CONSISTS OF 12	6 UNITS UTILIZING THE STA	TE DENSITY BONUS. THE BUILDING	3 BED TH	4
IS SEVEN STORIES WITH FIVE LEVELS OF	TYPE 3A OVER TWO LI	EVELS OF TYPE 1A . THERE	ARE 135 PARKING SPACES.	TOTAL	4 UN
				LEVEL 3	
CONSTRUCTION TYPE	PODIUM (5 FLOORS	OF WOOD OVER 2 FLOORS	OF CONCRETE)		
	TYPE 1A (GROUND F			STUDIO	10
	TYPE 3A (3RD TO 7T	H FLOOR)		1 BED	10 4
NUMBER OF STORIES PROPOSED	7			<u>2 BEDS</u> TOTAL	
				TOTAL	24 (
PROPOSED HEIGHT	75'			LEVEL 4	
				0.711.010	
OCCUPANCY TYPE	RESIDENTIAL	R-2		STUDIO 1 BED	9
	PARKING	S-2		2 BEDS	10 6
	MERCANTILE	M		TOTAL	<u>0</u> 25 L
				101712	20 0
PROPOSED DENSITY	FAR	5.26		LEVEL 5	
- NOT GOLD BLIGHT	DENSITY	157.5 D.U./ACRE			
				STUDIO	9
PROPOSED NUMBER OF UNITS	STUDIO	52		1 BED	10 7
	ONE BEDROOM	50		<u>2 BEDS</u> TOTAL	26 L
	TWO BEDS THREE BED TH.	20 4		101712	20 0
	TOTAL	126 UNITS		LEVEL 6	
	101/12	120 011110		,	
	26 OF THESE UNITS	ARE AFFORDABLE UNITS (20.6%)	STUDIO	12
				1 BED	11
				<u>2 BEDS</u> TOTAL	ı 24 l
PARKING PROVIDED	GROUND FLOOR		60 SPACES	TOTAL	24 (
	SECOND FLOOR		67 SPACES	LEVEL 7	
	TOTAL		127 SPACES PROV'D		
			94,1%	STUDIO	12
SEE SHEET 006-S			5.1,1.15	1 BED	9
				<u>2 BEDS</u> TOTAL	2 23 L
COMMERCIAL SPACES @ 1 PER 200 SF =	1626/200 = 8.13 = 9 SPA	ACES		TOTAL	25 0
				TOTAL NUMBER (OF UNITS
BIKE PARKING PROVIDED				0.0500 711	
SEE SHEET 006-S				3 BEDS - TH STUDIO	4 52
OLL GILLI 300-0				1 BED	52 50
COMMERCIAL SPACES @ 1 PER 3000 SF =	= 1626/3000 = .54 = 1 SP.	ACE		2 BEDS	20
			LESS THAN 20% CHANGES	TOTAL	126 L
					100
				LE	ESS THAN 2

PROPOSED PROJECT DATA (CA GOV CODE 65589.5(D)(5) "BUILDER'S REMEDY"

AREA BRE	ΕΔΚΙΙΡ			2022 2022 2022 2022 2022	CALIFORNIA BUILDING CALIFORNIA MECHAN CALIFORNIA PLUMBIN CALIFORNIA ELECTRIG CALIFORNIA FIRE COI CALIFORNIA GREEN B CALIFORNIA ENERGY	ICAL CODE (ĆN G CODE (CPC) CAL CODE (CE DE (CFC) UILDING STAN) C) IDARD CODE ((
UILDING TYPE		GARAGE	RETAIL	CIRCULATION	RESIDENTIAL (NET)	AMENITY	
	LEVEL 1	23'455 SF	1'626 SF	1'172 SF	2'304 SF	853 SF	TYPE IA
TYPE IA	LEVEL 2	22'353 SF		1'333 SF	2'572 SF	929 SF	
	TOTAL	45'808 SF	1626 SF	2505 SF	4876 SF	1782 SF	56'597 SF
				I	I		
	LEVEL 3			3'639 SF	14'923 SF	12'823 SF	
	LEVEL 4			3'232 SF	16'047 SF	932 SF	
TYPE IIIA	LEVEL 5			3'233 SF	16'837 SF		TYPE IIIA
	LEVEL 6			3'224SF	13'109 SF	1'591 SF	111 2 111/4
	LEVEL 7			3'045 SF	12'648 SF	807 SF	
	TOTAL			16'373 SF	73'564 SF	16'153 SF	106'090 SF
	1						
PROJECT	TOTAL	45'808 SF	1626 SF	18'878 SF	78'440 SF	17'935 SF	162'687 SF
							88,5%

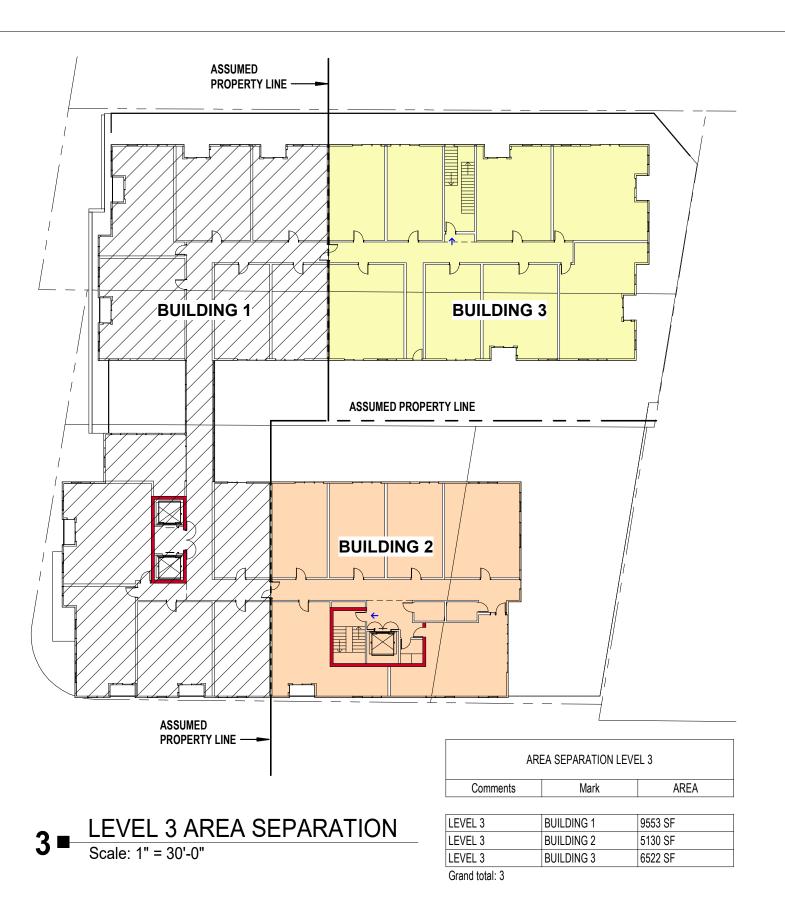

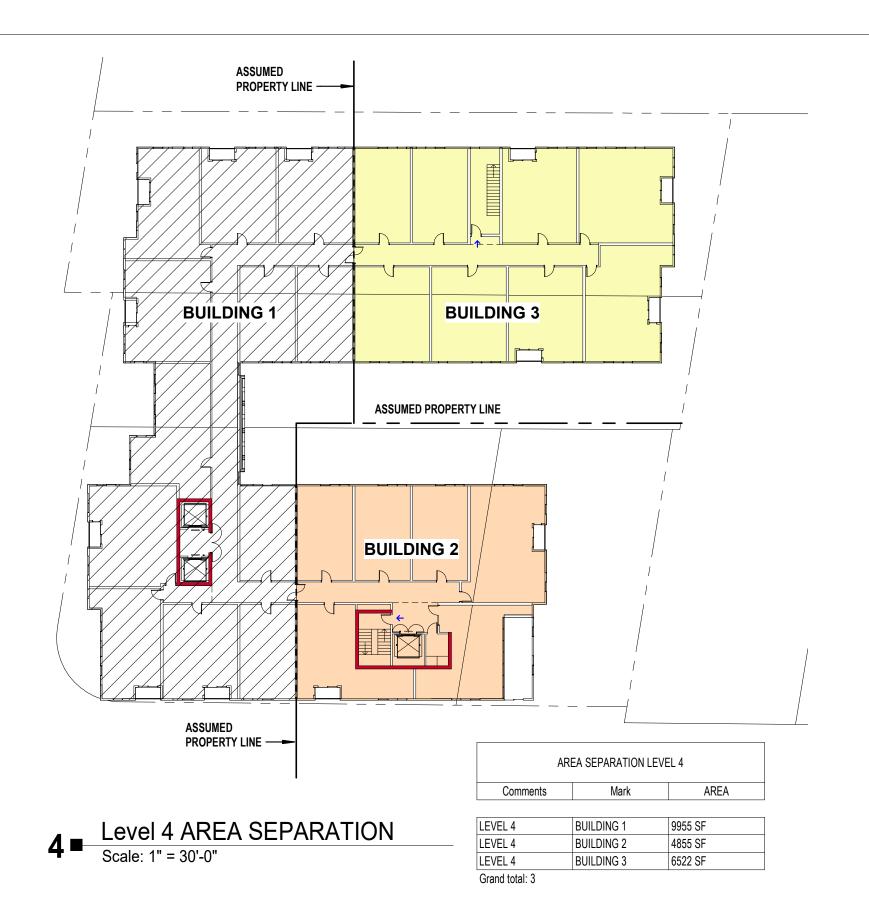

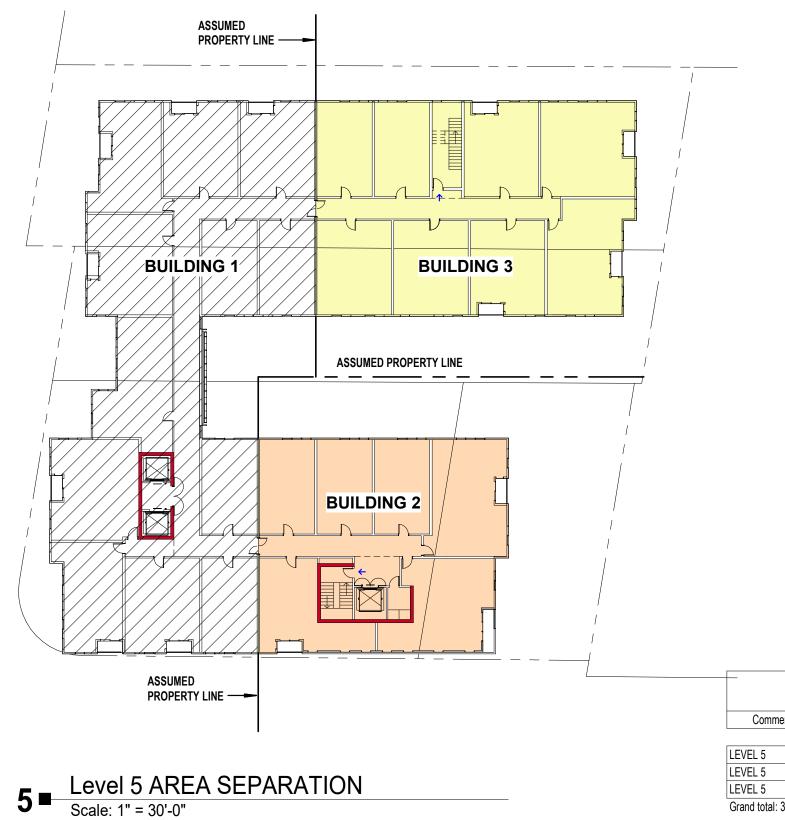

AREA SEPARATION LEVEL 5 Mark BUILDING 2 5046 SF BUILDING 3 Grand total: 3

FIRE WALLS SHALL EXTEND FROM THE FOUNDATION TO A TERMINATION POINT NOT LESS THAN 30 INCHES

TWO-HOUR FIRE-RESISTANCE-RATED WALLS SHALL BE PERMITTED TO TERMINATE AT THE UNDERSIDE OF

THE LOWER ROOF ASSEMBLY WITHIN 4 FEET (1220 MM) OF THE WALL HAS NOT LESS THAN A 1-HOUR FIRE-

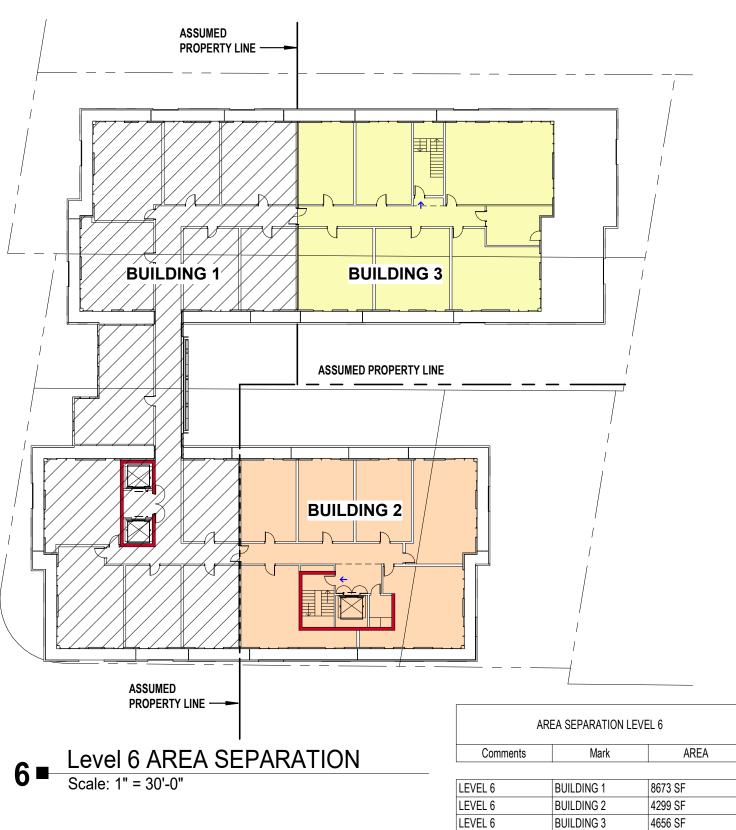
RESISTANCE RATING AND THE ENTIRE LENGTH AND SPAN OF SUPPORTING ELEMENTS FOR THE RATED

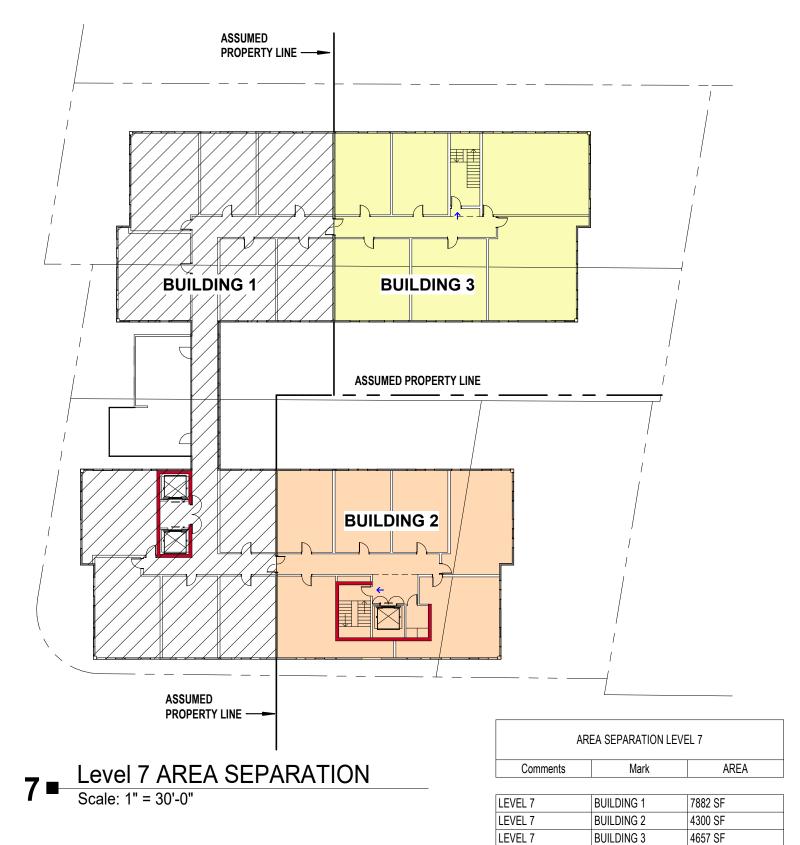
PER EQUATION 5-2: EACH BUILDING AREA IS 24,000 X 2 = 48,000 SF MAX

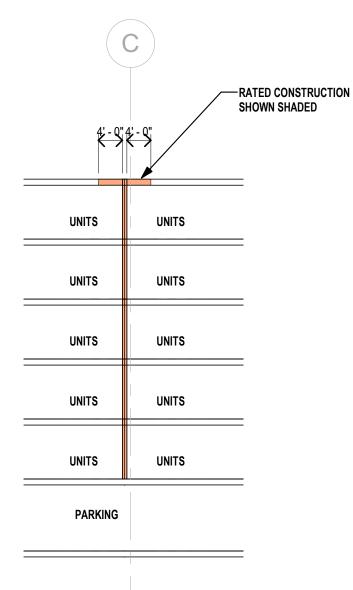
OPENINGS IN THE ROOF SHALL NOT BE LOCATED WITHIN 4 FEET (1220 MM) OF THE FIRE WALL. EACH BUILDING SHALL BE PROVIDED WITH NOT LESS THAN A CLASS B ROOF COVERING.

AREA SEPARATION- BUILDING 1

Comments Mark AREA







LEVEL 3 BUILDING 1 9553 SF LEVEL 4 BUILDING 1 9955 SF LEVEL 5 BUILDING 1 9955 SF LEVEL 6 BUILDING 1 8673 SF LEVEL 7 BUILDING 1 7882 SF 46018 SF

706.6 VERTICAL CONTINUITY

(762 MM) ABOVE BOTH ADJACENT ROOFS.

EXCEPTIONS: STEPPED BUILDINGS IN ACCORDANCE WITH SECTION 706.6.1.

ROOF ASSEMBLY HAS A FIRE-RESISTANCE RATING OF NOT LESS THAN 1 HOUR.

THE ROOF SHEATHING, DECK OR SLAB, PROVIDED THAT:

AREA SEPARATION- BUILDING 2 Comments Mark AREA LEVEL 3 BUILDING 2 5130 SF LEVEL 4 BUILDING 2 4855 SF LEVEL 5 BUILDING 2 5046 SF LEVEL 6 BUILDING 2 4299 SF LEVEL 7 BUILDING 2 4300 SF


AREA SEPARATION- BUILDING 3						
Comments	Mark	AREA				
LEVEL 3	BUILDING 3	6522 SF				
LEVEL 4	BUILDING 3	6522 SF				
LEVEL 5	BUILDING 3	6521 SF				
LEVEL 6	BUILDING 3	4656 SF				
LEVEL 7	BUILDING 3	4657 SF				
5		28878 SF				

TABLE 504.3

Grand total: 3

ALLOWABLE BUILDING HEIGHT IN FEET ABOVE GRADE PLANE a, i

	TYPE OF CONSTRUCTION												
OCCUPANCY CLASSIFICATION	See Type I		Тур	Type II Type		Type III		Type IV				Type V	
	Footnotes	Α	В	Α	В	Α	В	Α	В	С	нт	Α	В
	NS ^d	UL	160	65	55	65	55	65	65	65	65	50	40
	S13R	60	60	60	55	60	55	60	60	60	60	50	40
R-2 ^h	S (without area increase)	UL	180	85	75	85	75	270	180	85	85	70	60
	S (with area increase)	UL	160	65	55	65	55	250	160	65	65	60 j	40

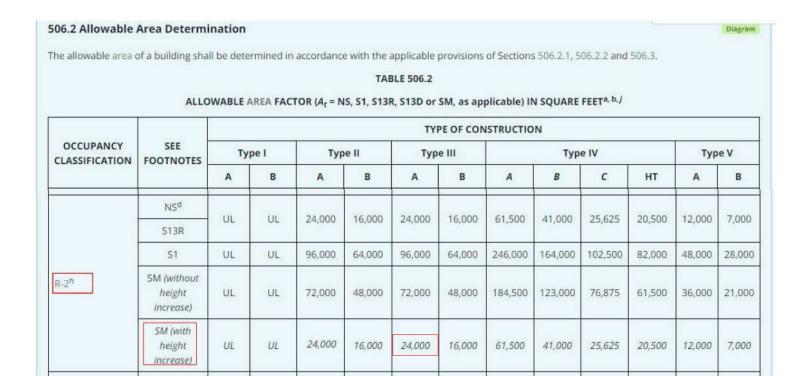

Grand total: 3

506.2.3 Single-Occupancy, Multistory Buildings

grade plane shall be determined in accordance with Equation 5-2: (Equation 5-2) $A_a = [A_t + (NS \times I_f)] \times S_a$

The allowable area of a single-occupancy building with more than one story above

where:

Section 506.3.

 A_a = Allowable area (square feet). $A_{\rm t}$ = Tabular allowable area factor (NS, S13R, S13D or SM value, as applicable) in accordance with Table 506.2.

NS = Tabular allowable area factor in accordance with Table 506.2 for a nonsprinklered building (regardless of whether the building is sprinklered). I_f = Area factor increase due to frontage (percent) as calculated in accordance with

S_o = For other than Group A, E, H, I, L and R occupancies, high-rise buildings, and other applications listed in Section 1.11 regulated by the Office of the State Fire Marshal, actual number of building stories above grade plane, not to exceed three. For Group A, E, H, I, L and R occupancies, high-rise buildings, and other applications listed in Section 1.11 regulated by the Office of the State Fire Marshal, actual number of building stories above grade plane, not to exceed two.

No individual story shall exceed the allowable area (A_a) as determined by Equation 5-2 using the value of $S_a = 1$.

STUDIO CURRENT 96 N. Third Street, Suite 110, San Jose, CA, 95112 T. 408.816.2000 www.studiocurrent.com

940 Willow Street

Mixed Use Proposal

Consultant

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H23-030 SITE DEVELOPMENT PERMIT

Revision


SITE DEVELOPMENT 10.05.2023 **REVISION 1** 12.01.2023




Sheet Information

Issue Date	12/01/2023
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Drawn	Author
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Scale	As indicated
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AREA SEPARATION



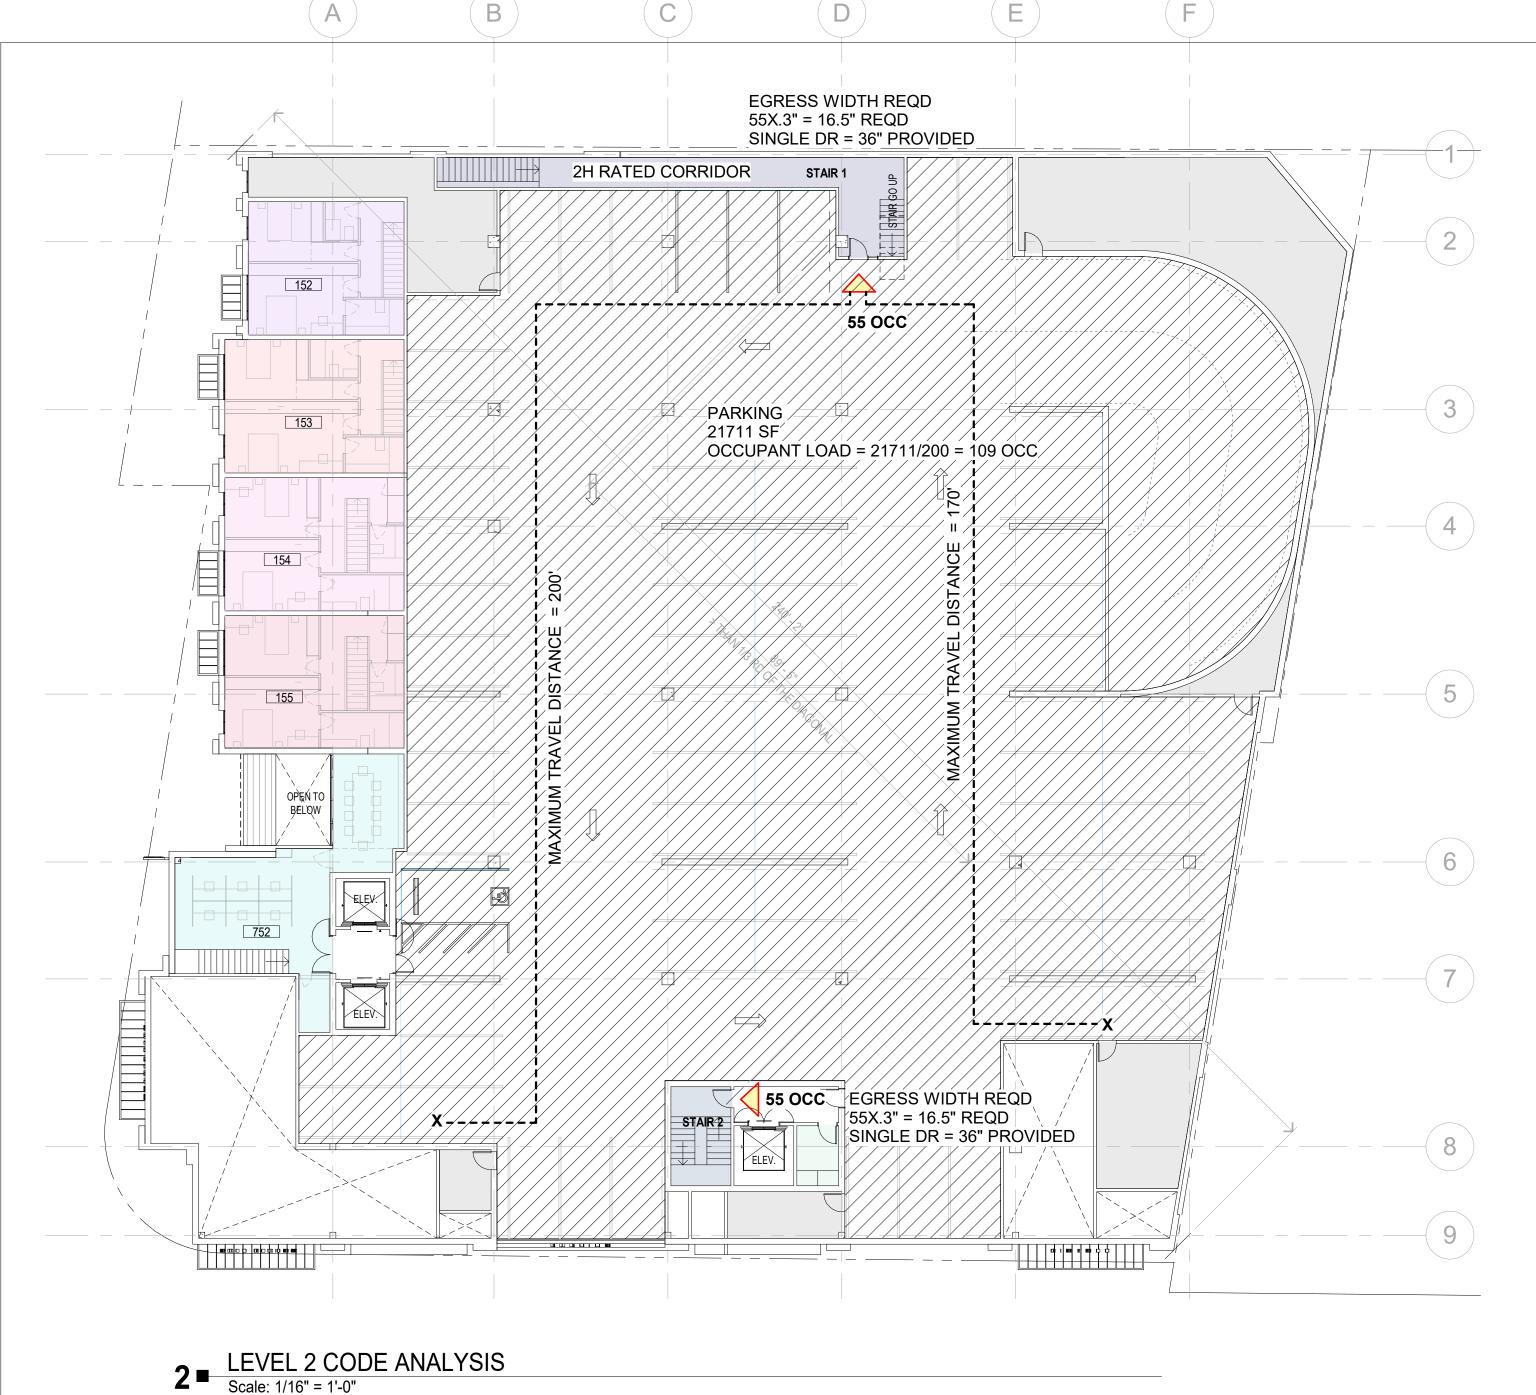

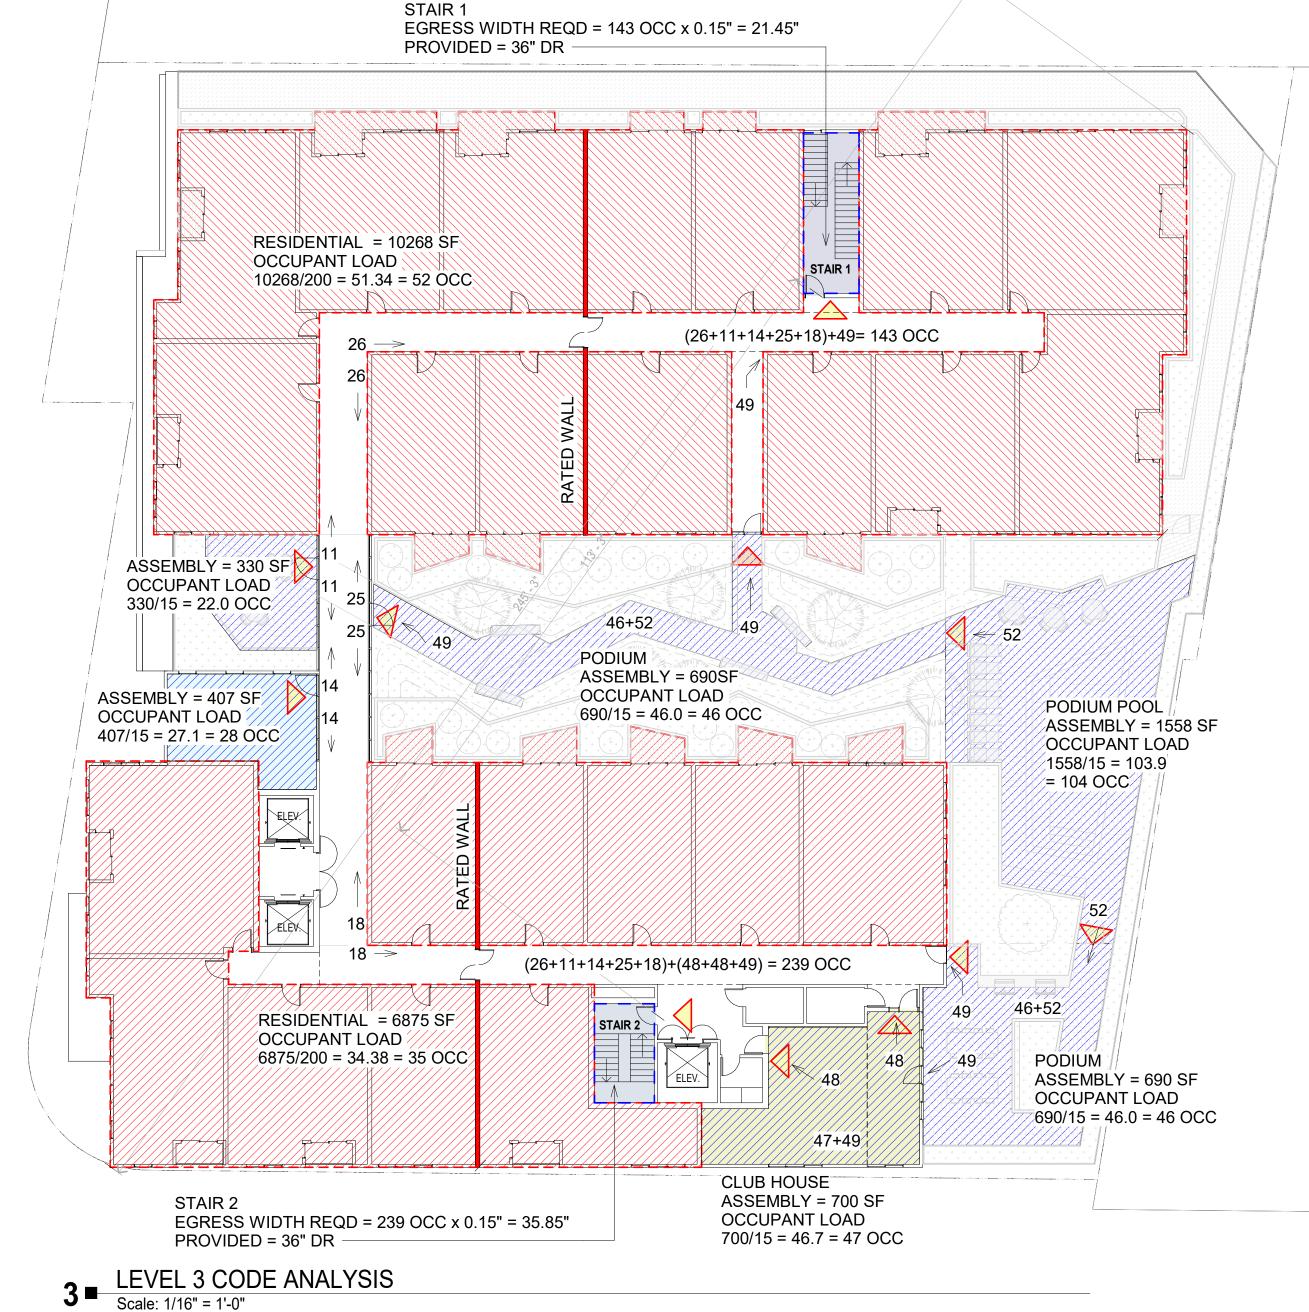COMMON OPEN SPACE 20.55.102 - COMMON AND PRIVATE OPEN SPACE REQUIREMENTS

IS THE OUTDOOR SPACE PROVIDED FOR RECREATION OF ALL RESIDENTS OF A PROJECT. EACH RESIDENTIAL OR MIXED USE DEVELOPMENT SHALL COMPLY WITH THE FOLLOWING COMMON OPEN SPACE REQUIREMENTS:

1.MIXED USE DEVELOPMENT PROJECTS SHALL PROVIDE COMMON OPEN SPACE AT A MINIMUM OF 75 SQUARE FEET PER RESIDENTIAL UNIT

Level	Name	Area
Level 1	Common Open Space	853 SF
Level 2	Common Open Space	781 SF
Level 3	Common Open Space	10557 SF
Level 4	Common Open Space	679 SF
Level 6	Common Open Space	1591 SF
Level 7	Common Open Space	807 SF
		15268 SF

20.55.102 - COMMON AND PRIVATE OPEN SPACE REQUIREMENTS

IS THE OUTDOOR SPACE ATTACHED TO A LIVING UNIT AND PROVIDED FOR THE USE OF THE RESIDENTS OF

B.UNITS WITH 2 OR MORE BEDROOMS SHALL PROVIDE A MINIMUM OF 45 SQUARE FEET PER RESIDENTIAL UNIT;

UNIT TYPE

SECTION

SECTION 302,

303.1.2,

OCCUPANCY TYPE

CBC 2019 CODE | BLDG LEVEL

LEVEL 2

LEVEL 3-7

Level	Name	Count	Level	Name	Count		Level	Name	Count		Level	Name	Count
Level 1	TH	4	Level 3	ST	10		Level 3	1 BDR	10		Level 3	2 BDR	4
4			Level 4	ST	9	1	Level 4	1 BDR	10		Level 4	2 BDR	6
			Level 5	ST	9	1	Level 5	1 BDR	10		Level 5	2 BDR	7
			Level 6	ST	12	l	Level 6	1 BDR	11		Level 6	2 BDR	1
			Level 7	ST	12	l	Level 7	1 BDR	9		Level 7	2 BDR	2
			52			Γ	50			Г	20		

OCCUPANCY TYPE

GROUND LEVEL LOW HAZARD STORAGE, GROUP S-2, B, U

GROPU S-2, R-2

TOTAL = 4+ 52+ 50+ 20 = 126 UNITS

THE LIVING UNIT. PRIVATE OPEN SPACE CAN OCCUR IN THE FORM OF A PATIO, BALCONY, DECK, OR REAR YARD. THE PRIVATE OPEN SPACE REQUIREMENT IS CALCULATED BASED ON THE TOTAL NUMBER OF UNITS AND EACH DEVELOPMENT SHALL MEET THE FOLLOWING PRIVATE OPEN SPACE REQUIREMENTS

1.MIXED USE DEVELOPMENT PROJECTS SHALL PROVIDE PRIVATE OPEN SPACE IN THE FOLLOWING MANNER: A.STUDIOS AND 1 BEDROOM UNITS SHALL PROVIDE A MINIMUM OF 30 SQUARE FEET PER RESIDENTIAL UNIT;

PRIVATE OPEN SPACE

	_	
Name	Area	REQ
Private Open Space	1243 SF	TOT
Private Open Space	517 SF	
Private Open Space	575 SF	PER PRI\
Private Open Space	3007 SF	FOLI
	Name Private Open Space Private Open Space Private Open Space	Private Open Space 1243 SF Private Open Space 517 SF Private Open Space 575 SF

EQUIRED = STUDIO & 1 BDR = 102 X 30 = 3,060 SF = 2 BDR = 21 X 45 = 945 SF AL REQUIRED = 3,060+ 945 = 4,005 SF

REQUIRED = 126 X 75 = 9,450 SF

R 20.55.102(D): DEVELOPMENT PROJECTS MAY REDUCE THEIR VATE OPEN SPACE REQUIREMENT BY UP TO 50% UNDER THE LLOWING CONDITIONS: UP TO 50% OF THE TOTAL PRIVATE OPEN SPACE REQUIREMENT MAY BE FUFILLED THROUGH THE DEVELOPMENT OF AN EQUIVALENT AMOUNT OF COMMON OPEN SPACES.

TABLE 508.4 MIXED OCCUPANCIES

LEVEL	MIXED OCCUPANCIES	OF SEPARATION OF OCCUPANCIES
GROUND LEVEL	S2 /B/ R2	1
LEVEL 2	S2 / R-2	1
LEVEL 3	R-2 /A3	1
LEVEL 4	R-2/ A3	1
LEVEL 5	R-2	-
LEVEL 6	R-2/A3	1
LEVEL 7	R-2	-

TABLE 1020.2 CORRIDOR FIRE RATING					
OCCUPANCY TYPE	CORRIDOR WITH SPRINKLER SYSTEM				
R-2	1 HOUR IF GREATER THAN 10				
S-2	0				
A-2	0				
В	0				

MINIMUM CORRIDOR WIDTH (PER TABLE 1020.1) THE MINIMUM CORRIDOR WIDTH IN PUBLIC AREA IS 44" FOR THE IN RESIDENTIAL UNIT IS 36". ALL CORRIDORS PROVIDED ARE AT LEAST 6 FEET, EXCEEDING THE REQUIRED WIDTH.

TABLE 504.3 ALLOWABLE HEIGHT OCCUPANCY TYPE OF HEIGHT ALLOWED CONSTRUCTION B, S, A TYPE I A UNLIMITED TYPE III A TYPE III A WITHOUT AREA INCREASE

TABLE 506.2 ALLOWABLE FLOOR AREA						
OCCUPANCY	TYPE OF CONSTRUCTION	ALLOWABLE AREA				
B, S, A	TYPEIA	UNLIMITED				
R-2 WITH HEIGHT INCREASE	TYPE III A	ALLOWABLE FLOOR AREA = 24,000 SF PER 506.2.3 24,000 X 2 = 48,000SF/5 = 9,600 SF FOR AREA SEPARATION SEE SHEET 002-A FULLY SPRINKLERED AS PER NFPA 13				

1005.3.2 OTHER EGRESS COMPONENTS

CALCULATE THE CAPACITY, IN INCHES, OF MEANS OF EGRESS COMPONENTS OTHER THAN STAIRWAYS SHALL BE OCCUPANCIES R-2, S-2, A-2 AND B, THE MINIMUM CORRIDOR WIDTH

CALCULATED BY MULTIPLYING THE OCCUPANT LOAD SERVED BY SUCH COMPONENT BY A MEANS OF EGRESS CAPACITY FACTOR OF 0.2 INCH (5.1 MM) PER OCCUPANT.

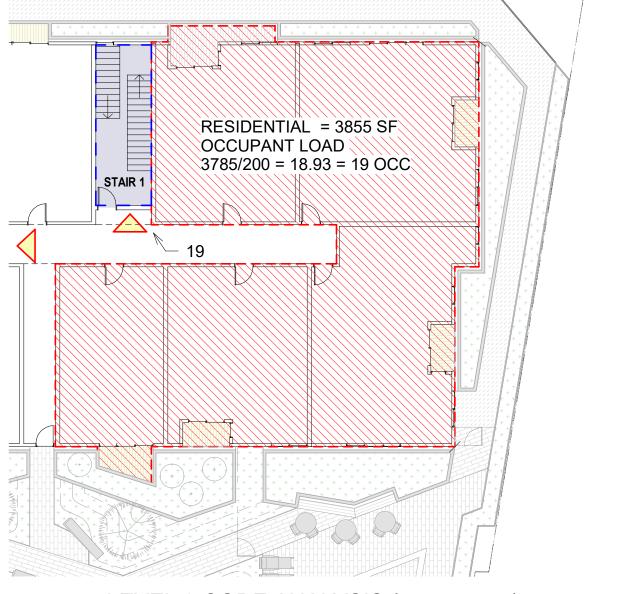
> FOR OTHER THAN GROUP H AND I-2 OCCUPANCIES, THE CAPACITY, IN INCHES, OF MEANS OF EGRESS COMPONENTS OTHER THAN STAIRWAYS SHALL BE CALCULATED BY MULTIPLYING THE OCCUPANT LOAD SERVED BY SUCH COMPONENT BY A MEANS OF EGRESS CAPACITY FACTOR OF 0.15 INCH (3.8 MM) PER OCCUPANT IN BUILDINGS EQUIPPED THROUGHOUT WITH AN AUTOMATIC SPRINKLER SYSTEM INSTALLED IN ACCORDANCE WITH SECTION 903.3.1.1 OR 903.3.1.2 AND AN EMERGENCY VOICE/ALARM COMMUNICATION SYSTEM IN ACCORDANCE WITH SECTION 907.5.2.2.

> 1007.1 GENERAL (1007.1.1 TWO EXITS OR EXIT ACCESS DOORWAYS) WHERE TWO EXITS, EXIT ACCESS DOORWAYS, EXIT ACCESS STAIRWAYS OR RAMPS, OR ANY COMBINATION THEREOF, ARE REQUIRED FROM ANY PORTION OF THE EXIT ACCESS, THEY SHALL BE PLACED A DISTANCE APART EQUAL TO NOT LESS THAN ONE-HALF OF THE LENGTH OF THE MAXIMUM OVERALL DIAGONAL DIMENSION OF THE BUILDING OR AREA TO BE SERVED MEASURED IN A STRAIGHT LINE BETWEEN THEM. INTERLOCKING OR SCISSOR STAIRWAYS SHALL BE COUNTED AS ONE EXIT STAIRWAY.

1010.1.2.1 DIRECTION OF SWING SIDE-HINGED SWINGING DOORS, PIVOTED DOORS AND BALANCED DOORS SHALL SWING IN THE DIRECTION OF EGRESS TRAVEL WHERE SERVING A ROOM OR AREA CONTAINING AN OCCUPANT LOAD OF 50 OR MORE PERSONS OR A GROUP H OCCUPANCY. FOR GROUP L OCCUPANCIES, SEE SECTION 453.6.2.

FFR (PER TABLE 601 AND 602)

BUILDING AREAS ARE SHOWN ON PLAN AND COMPLY WITH TYPE I-A (LEVEL 1-2) AND TYPE III-A (LEVEL 3-7) CONSTRUCTION TYPES. SLAB SEPARATING TYPE 1A FROM TYPE 3A IS 3-HOUR SEPARATION. WOOD FRAMED APARTMENT UNITS (UPPER 5 LEVELS) ARE TYPE III-A W/ SPRINKLERS



LEVEL 3 CODE ANALYSIS (east corner)

Scale: 1/16" = 1'-0"



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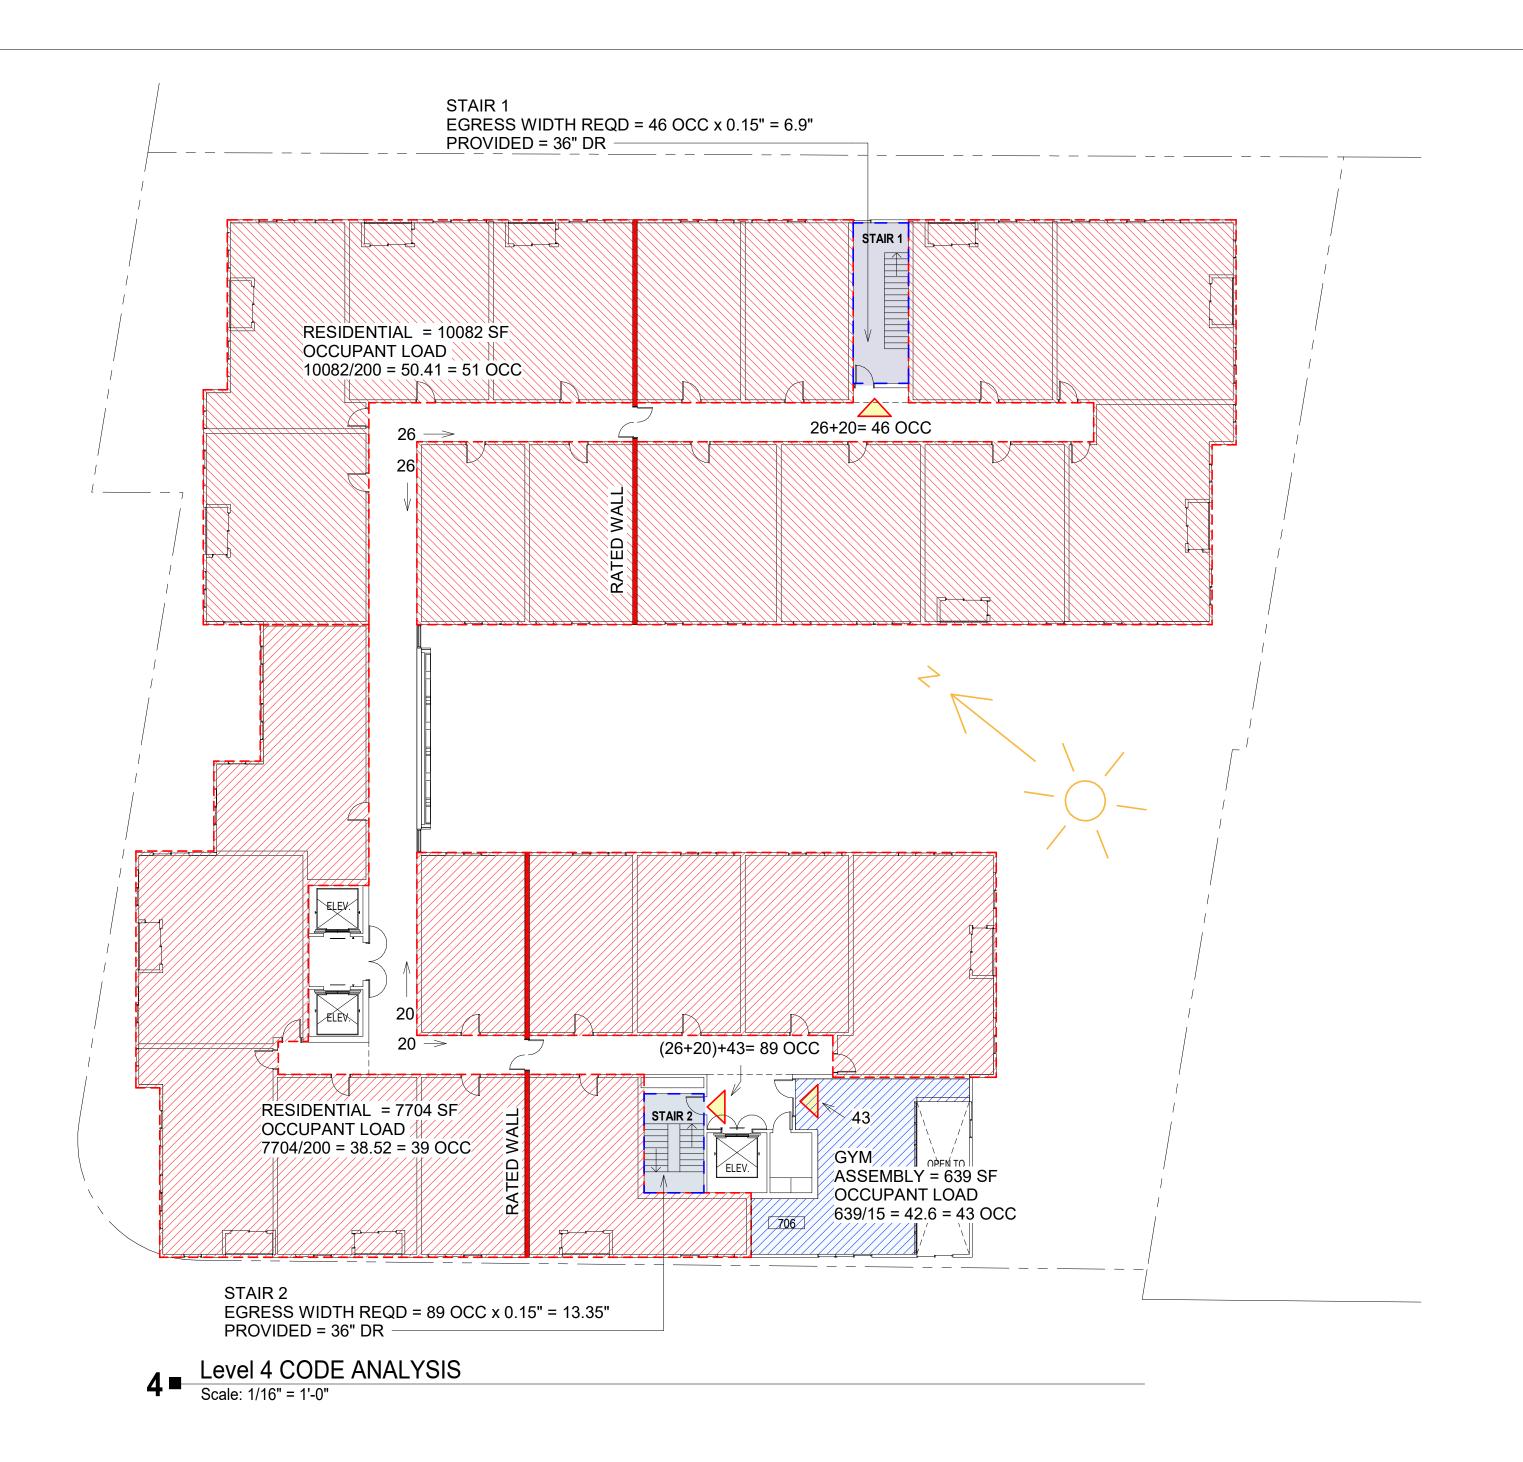
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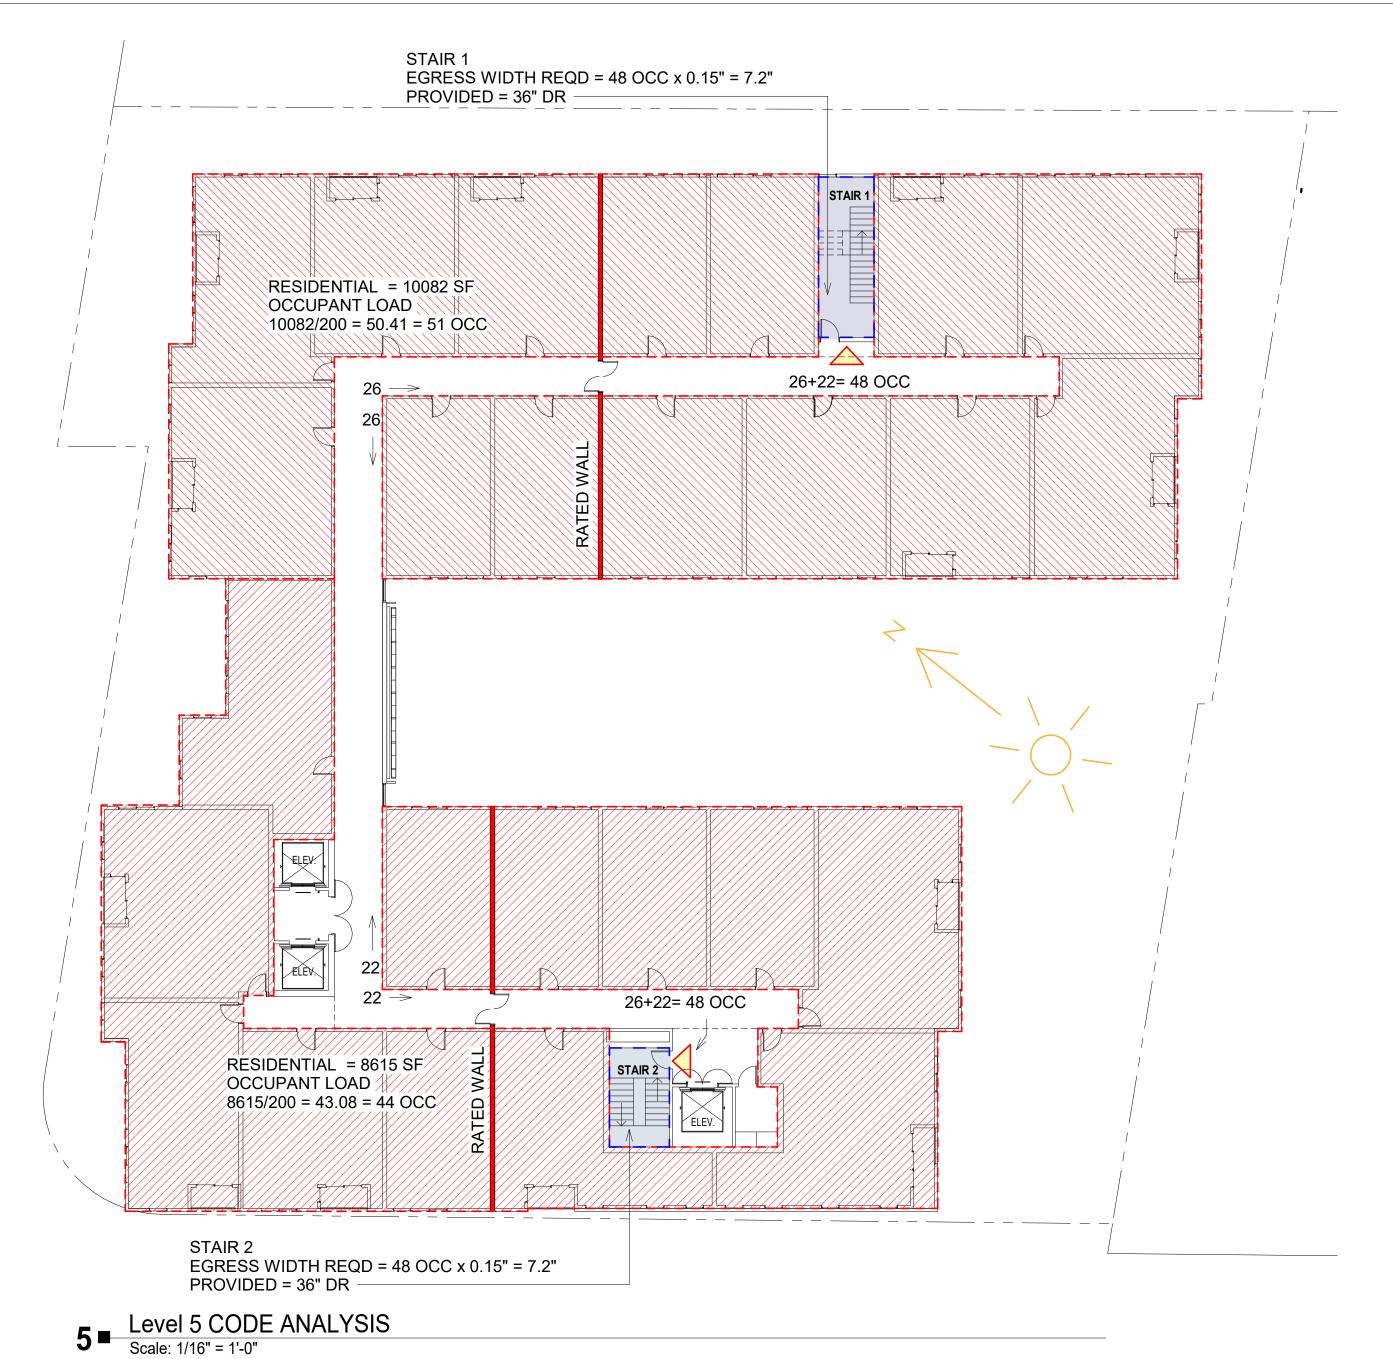


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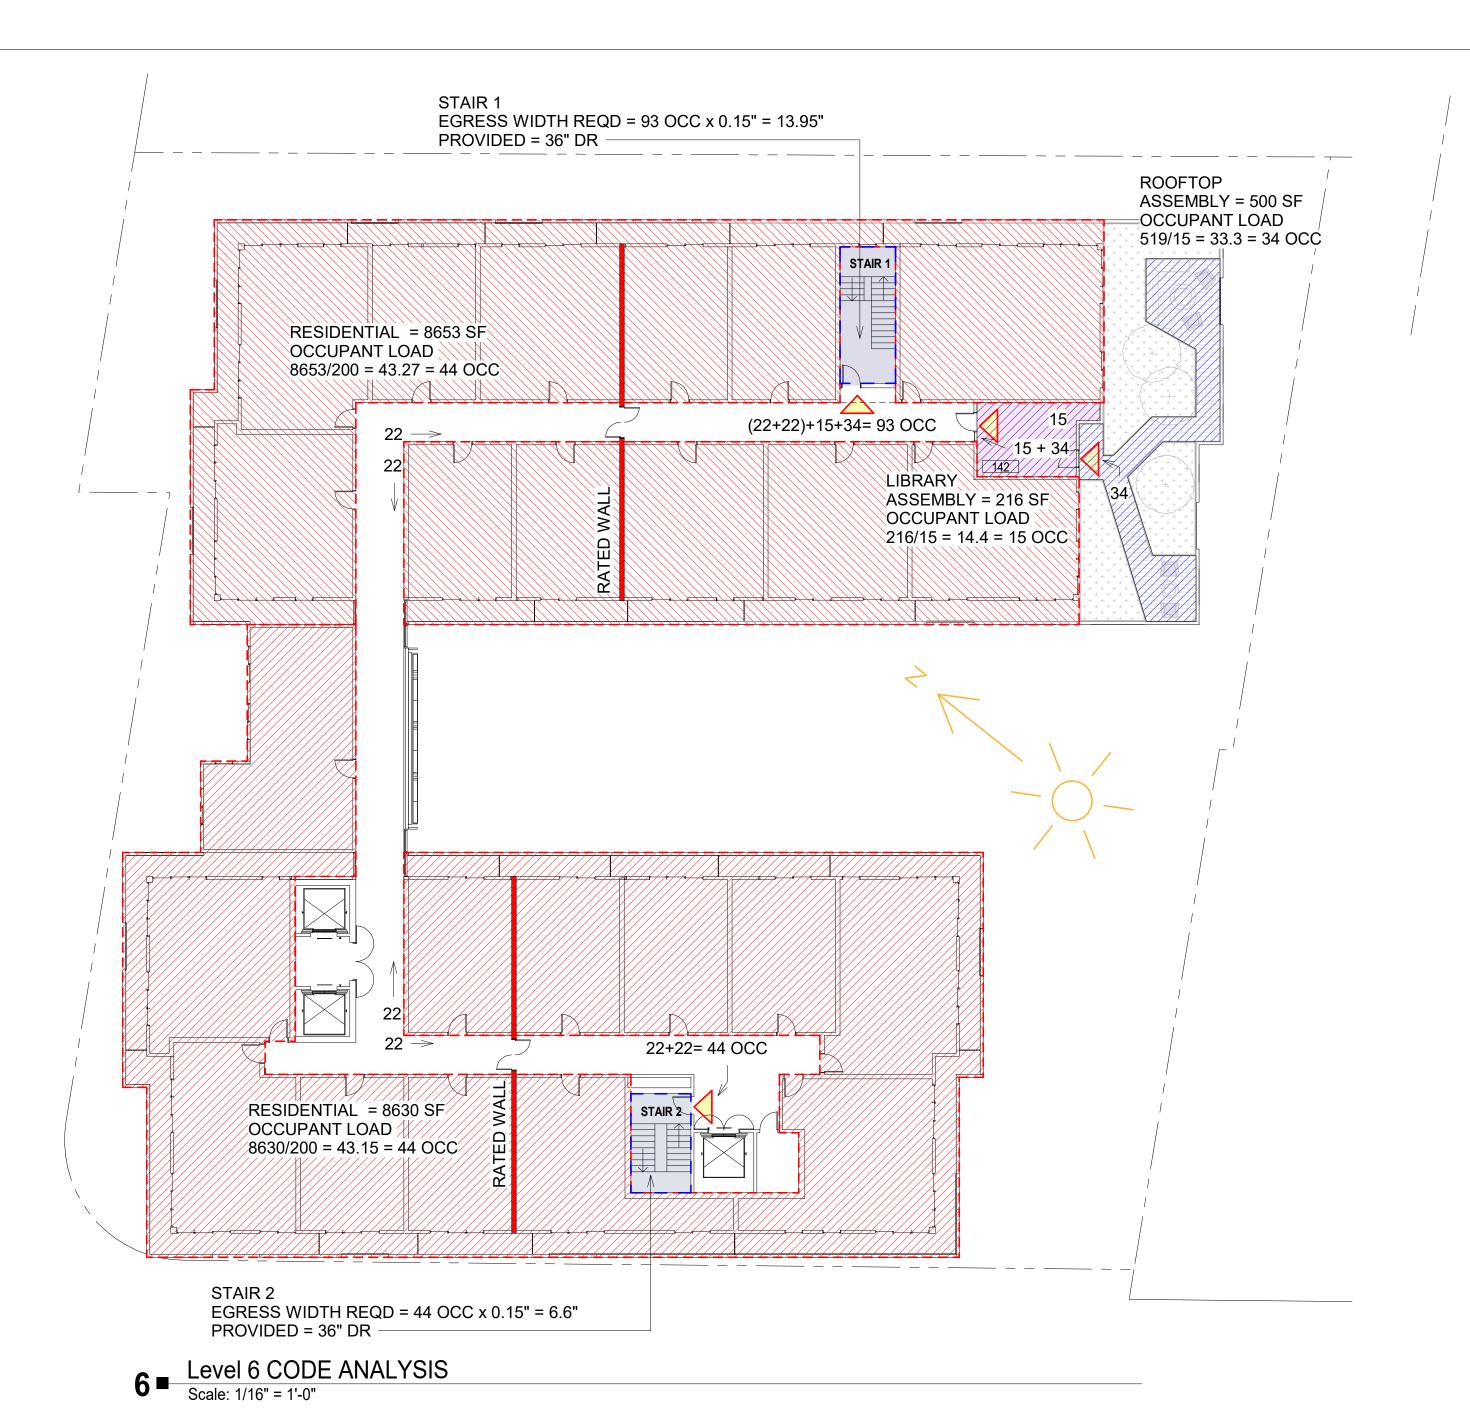



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Issue Date	12/01/2023
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003B-G




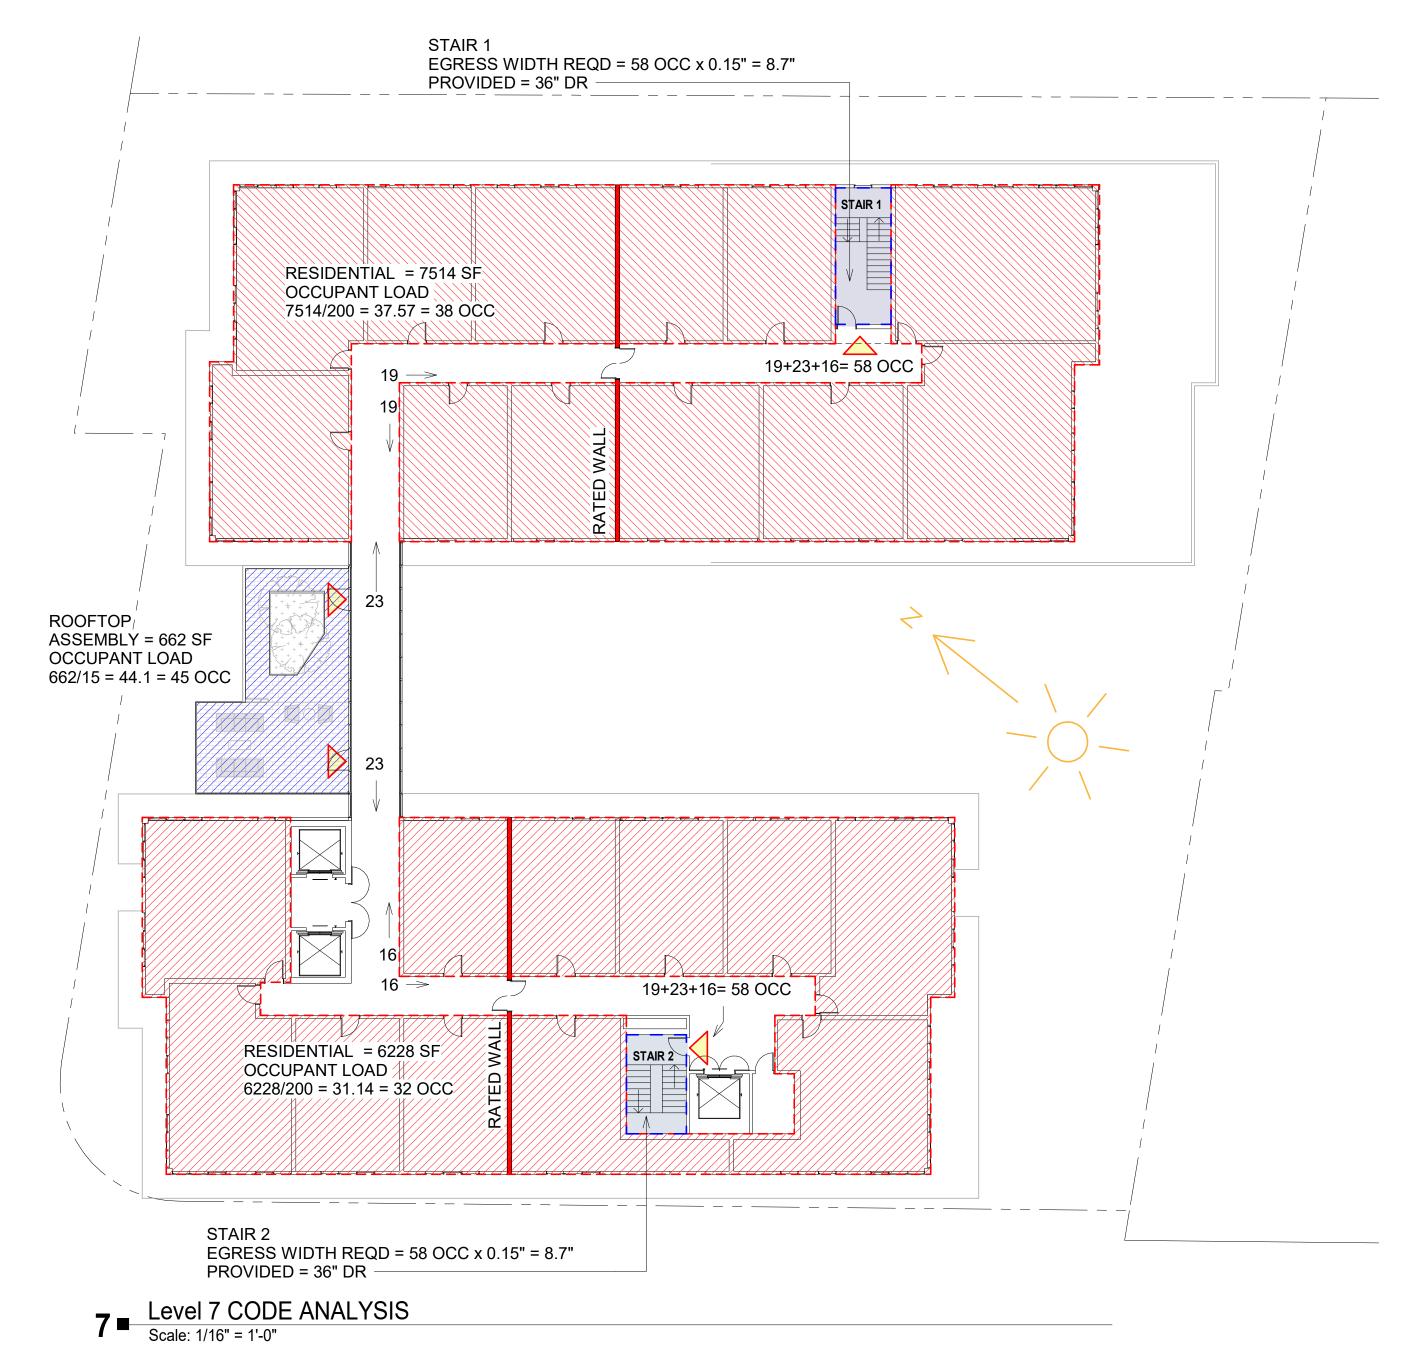
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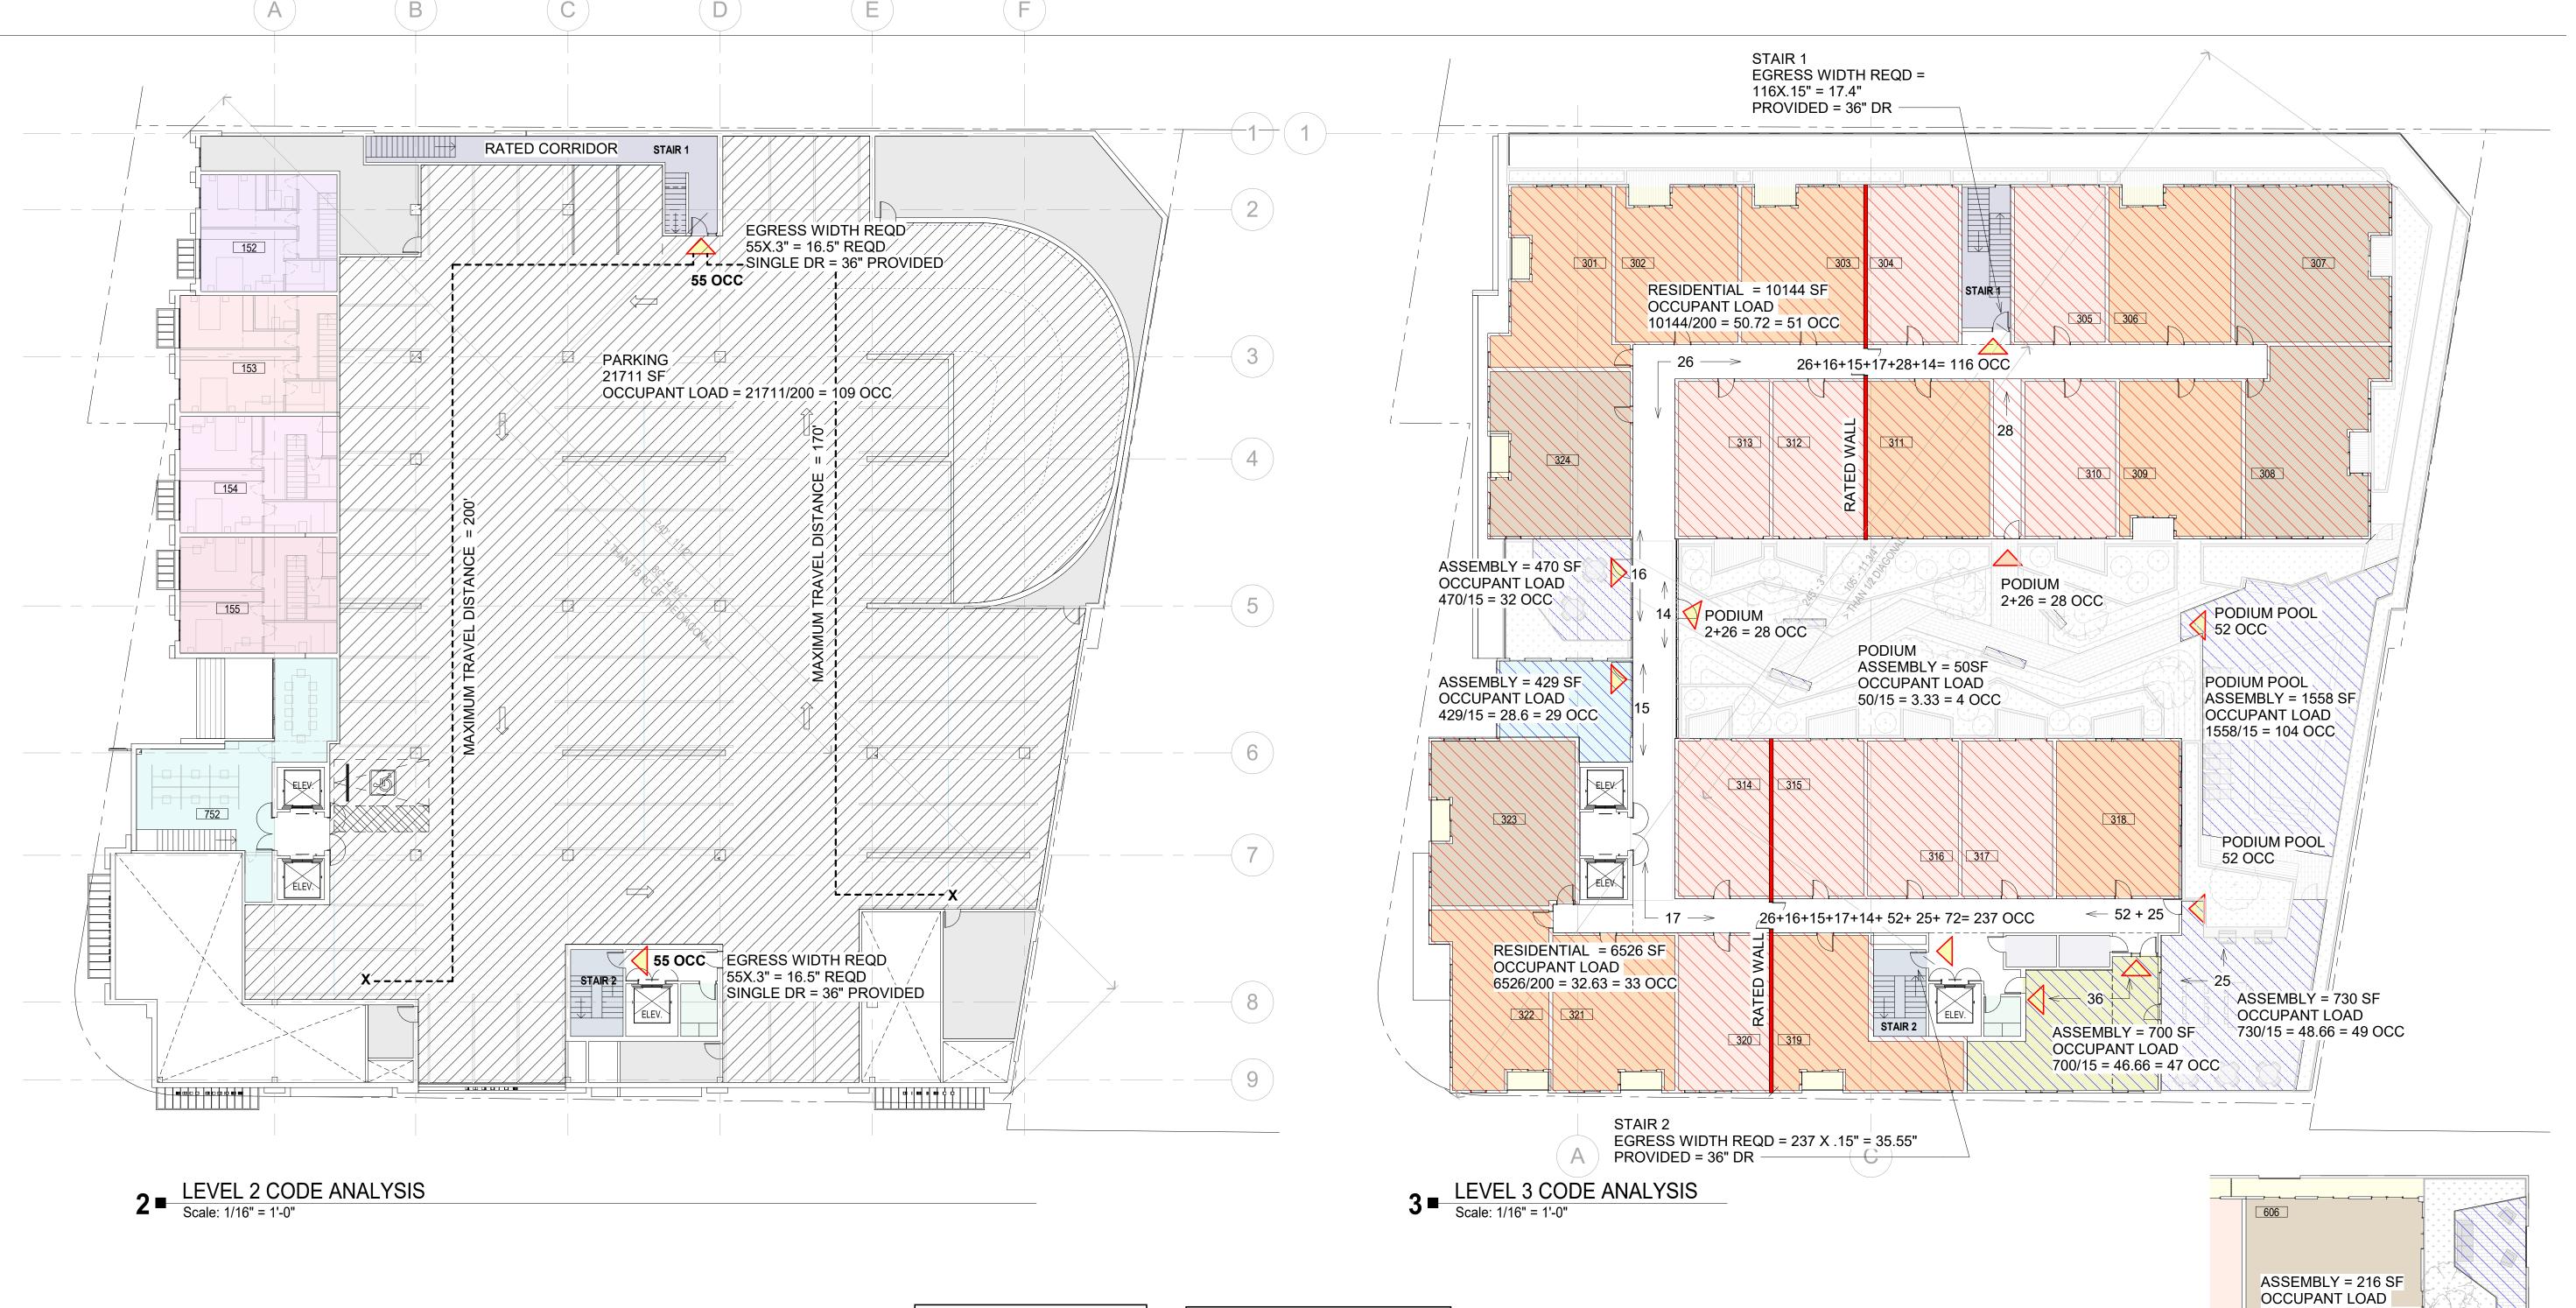


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CODE ANALYSIS

003C-G



COMMON OPEN

20.55.102 - COMMON AND PRIVATE OPEN SPACE REQUIREMENTS

1.MIXED USE DEVELOPMENT PROJECTS SHALL PROVIDE COMMON OPEN SPACE AT A MINIMUM OF 75 SQUARE FEET PER RESIDENTIAL UNIT

REQUIRED = 126 X 75 = 9,450 SF

Level	Name	Area
Level 1	Common Open Space	853 SF
Level 2	Common Open Space	781 SF
Level 3	Common Open Space	10557 SF
Level 4	Common Open Space	679 SF
Level 6	Common Open Space	1591 SF
Level 7	Common Open Space	807 SF
		15268 SF

20.55.102 - COMMON AND PRIVATE OPEN SPACE REQUIREMENTS

THE LIVING UNIT. PRIVATE OPEN SPACE CAN OCCUR IN THE FORM OF A PATIO, BALCONY, DECK, OR REAR YARD. THE PRIVATE OPEN SPACE REQUIREMENT IS CALCULATED BASED ON THE TOTAL NUMBER OF UNITS

1.MIXED USE DEVELOPMENT PROJECTS SHALL PROVIDE PRIVATE OPEN SPACE IN THE FOLLOWING MANNER: B.UNITS WITH 2 OR MORE BEDROOMS SHALL PROVIDE A MINIMUM OF 45 SQUARE FEET PER RESIDENTIAL UNIT;

UNIT TYPE

SECTION

SECTION 302,

303.1.2,

OCCUPANCY TYPE

CBC 2019 CODE BLDG LEVEL

LEVEL 3-7

Level	Name	Count	Level	Name	Count	Level	Name	Count	Level	Name	Coun
Level 1	TH	4	Level 3	ST	10	Level 3	1 BDR	10	Level 3	2 BDR	4
4			Level 4	ST	9	Level 4	1 BDR	10	Level 4	2 BDR	6
			Level 5	ST	9	Level 5	1 BDR	10	Level 5	2 BDR	7
			Level 6	ST	12	Level 6	1 BDR	11	Level 6	2 BDR	1
			Level 7	ST	12	Level 7	1 BDR	9	Level 7	2 BDR	2
			52			50			20		

OCCUPANCY TYPE

GROUND LEVEL LOW HAZARD STORAGE, GROUP S-2, B, U

GROPU S-2, R-2

TOTAL = 4+ 52+ 50+ 20 = 126 UNITS

	TABLE 300.	4 WIINED OCC	UFAI
N SPACE	LEVEL	MIXED	REQUIR OF SEP OF OCC
NO AGE	GROUND LEVEL	S2 /B/ R2	1

IS THE OUTDOOR SPACE PROVIDED FOR RECREATION OF ALL RESIDENTS OF A PROJECT. EACH
RESIDENTIAL OR MIXED USE DEVELOPMENT SHALL COMPLY WITH THE FOLLOWING COMMON OPEN
SPACE REQUIREMENTS:
A MINER LIGE REVELOPMENT PROJECTS OF ALL PROVIDE COMMON OPEN OR AT A MINIMUM OF THE

LOVOI	T Tallio	71100
Level 1	Common Open Space	853 SF
Level 2	Common Open Space	781 SF
Level 3	Common Open Space	10557 SF
Level 4	Common Open Space	679 SF
Level 6	Common Open Space	1591 SF
Level 7	Common Open Space	807 SF
		15268 SF

IS THE OUTDOOR SPACE ATTACHED TO A LIVING UNIT AND PROVIDED FOR THE USE OF THE RESIDENTS OF AND EACH DEVELOPMENT SHALL MEET THE FOLLOWING PRIVATE OPEN SPACE REQUIREMENTS

A.STUDIOS AND 1 BEDROOM UNITS SHALL PROVIDE A MINIMUM OF 30 SQUARE FEET PER RESIDENTIAL UNIT;

PRIVATE OPEN SPACE

L 01 LIV 01 710	_
Name	Area
Private Open Space	1243 SF
Private Open Space	517 SF
Private Open Space	575 SF
	Name Private Open Space Private Open Space

Level 6 Private Open Space 3007 SF

REQUIRED = STUDIO & 1 BDR = 102 X 30 = 3,060 SF = 2 BDR = 21 X 45 = 945 SF TOTAL REQUIRED = 3,060+ 945 = 4,005 SF

TARI F 508.4 MIXED OCCUPANCIES

	OCCUPANCIES	OF OCCUPANCIE
GROUND LEVEL	S2 /B/ R2	1
LEVEL 2	S2 / R-2	1
LEVEL 3	R-2 /A3	1
LEVEL 4	R-2/ A3	1
LEVEL 5	R-2	-
LEVEL 6	R-2/A3	1
E\/E 7	Dγ	

MINIMUM CORRIDOR WIDTH (PER TABLE 1020.1) THE MINIMUM CORRIDOR WIDTH IN PUBLIC AREA IS 44" FOR THE OCCUPANCIES R-2, S-2, A-2 AND B, THE MINIMUM CORRIDOR WIDTH IN RESIDENTIAL UNIT IS 36". ALL CORRIDORS PROVIDED ARE AT LEAST 6 FEET, EXCEEDING THE REQUIRED WIDTH.

TABLE 1020.2 CORRIDOR FIRE RATING

CORRIDOR WITH SPRINKLER SYSTEM

1 HOUR IF GREATER THAN 10

TABLE 504 .3 ALLOWABLE HEIGHT				
OCCUPANCY	TYPE OF CONSTRUCTION	HEIGHT ALLOWED		
B, S, A	TYPE I A	UNLIMITED		
	TYPE III A	85'		
R-2 WITHOUT AREA INCREASE	TYPE III A	85'		

TABLE 506.2 ALLOWABLE FLOOR AREA			
OCCUPANCY	TYPE OF CONSTRUCTION	ALLOWABLE AREA	
B, S, A	TYPEIA	UNLIMITED	
R-2 WITH HEIGHT INCREASE	TYPE III A	ALLOWABLE FLOOR AREA = 24,000 SF PER 506.2.3 24,000 X 2 = 48,000SF/5 = 9,600 SF FOR AREA SEPARATION SEE SHEET 002-A FULLY SPRINKLERED AS PER NFPA 13	

1005.3.2 OTHER EGRESS COMPONENTS

CALCULATE THE CAPACITY, IN INCHES, OF MEANS OF EGRESS COMPONENTS OTHER THAN STAIRWAYS SHALL BE CALCULATED BY MULTIPLYING THE OCCUPANT LOAD SERVED BY SUCH COMPONENT BY A MEANS OF EGRESS CAPACITY FACTOR OF 0.2 INCH (5.1 MM) PER OCCUPANT.

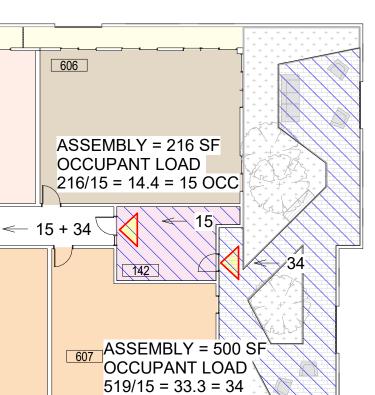
FOR OTHER THAN GROUP H AND I-2 OCCUPANCIES, THE CAPACITY, IN INCHES, OF MEANS OF EGRESS COMPONENTS OTHER THAN STAIRWAYS SHALL BE CALCULATED BY MULTIPLYING THE OCCUPANT LOAD SERVED BY SUCH COMPONENT BY A MEANS OF EGRESS CAPACITY FACTOR OF 0.15 INCH (3.8 MM) PER OCCUPANT IN BUILDINGS EQUIPPED THROUGHOUT WITH AN AUTOMATIC SPRINKLER SYSTEM INSTALLED IN ACCORDANCE WITH SECTION 903.3.1.1 OR 903.3.1.2 AND AN EMERGENCY VOICE/ALARM COMMUNICATION SYSTEM IN ACCORDANCE WITH SECTION 907.5.2.2.

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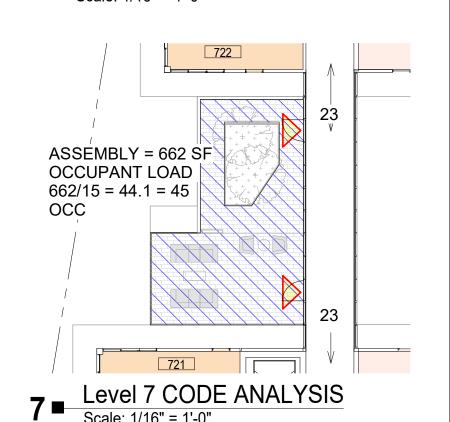
FFR (PER TABLE 601 AND 602) BUILDING AREAS ARE SHOWN ON PLAN AND COMPLY WITH TYPE I-A (LEVEL 1-2) AND TYPE III-A (LEVEL 3-7) SLAB SEPARATING TYPE 1A FROM TYPE 3A IS 3-HOUR SEPARATION.

WOOD FRAMED APARTMENT UNITS (UPPER 5 LEVELS) ARE TYPE III-A W/ SPRINKLERS



6 Level 6 CODE ANALYSIS Scale: 1/16" = 1'-0"

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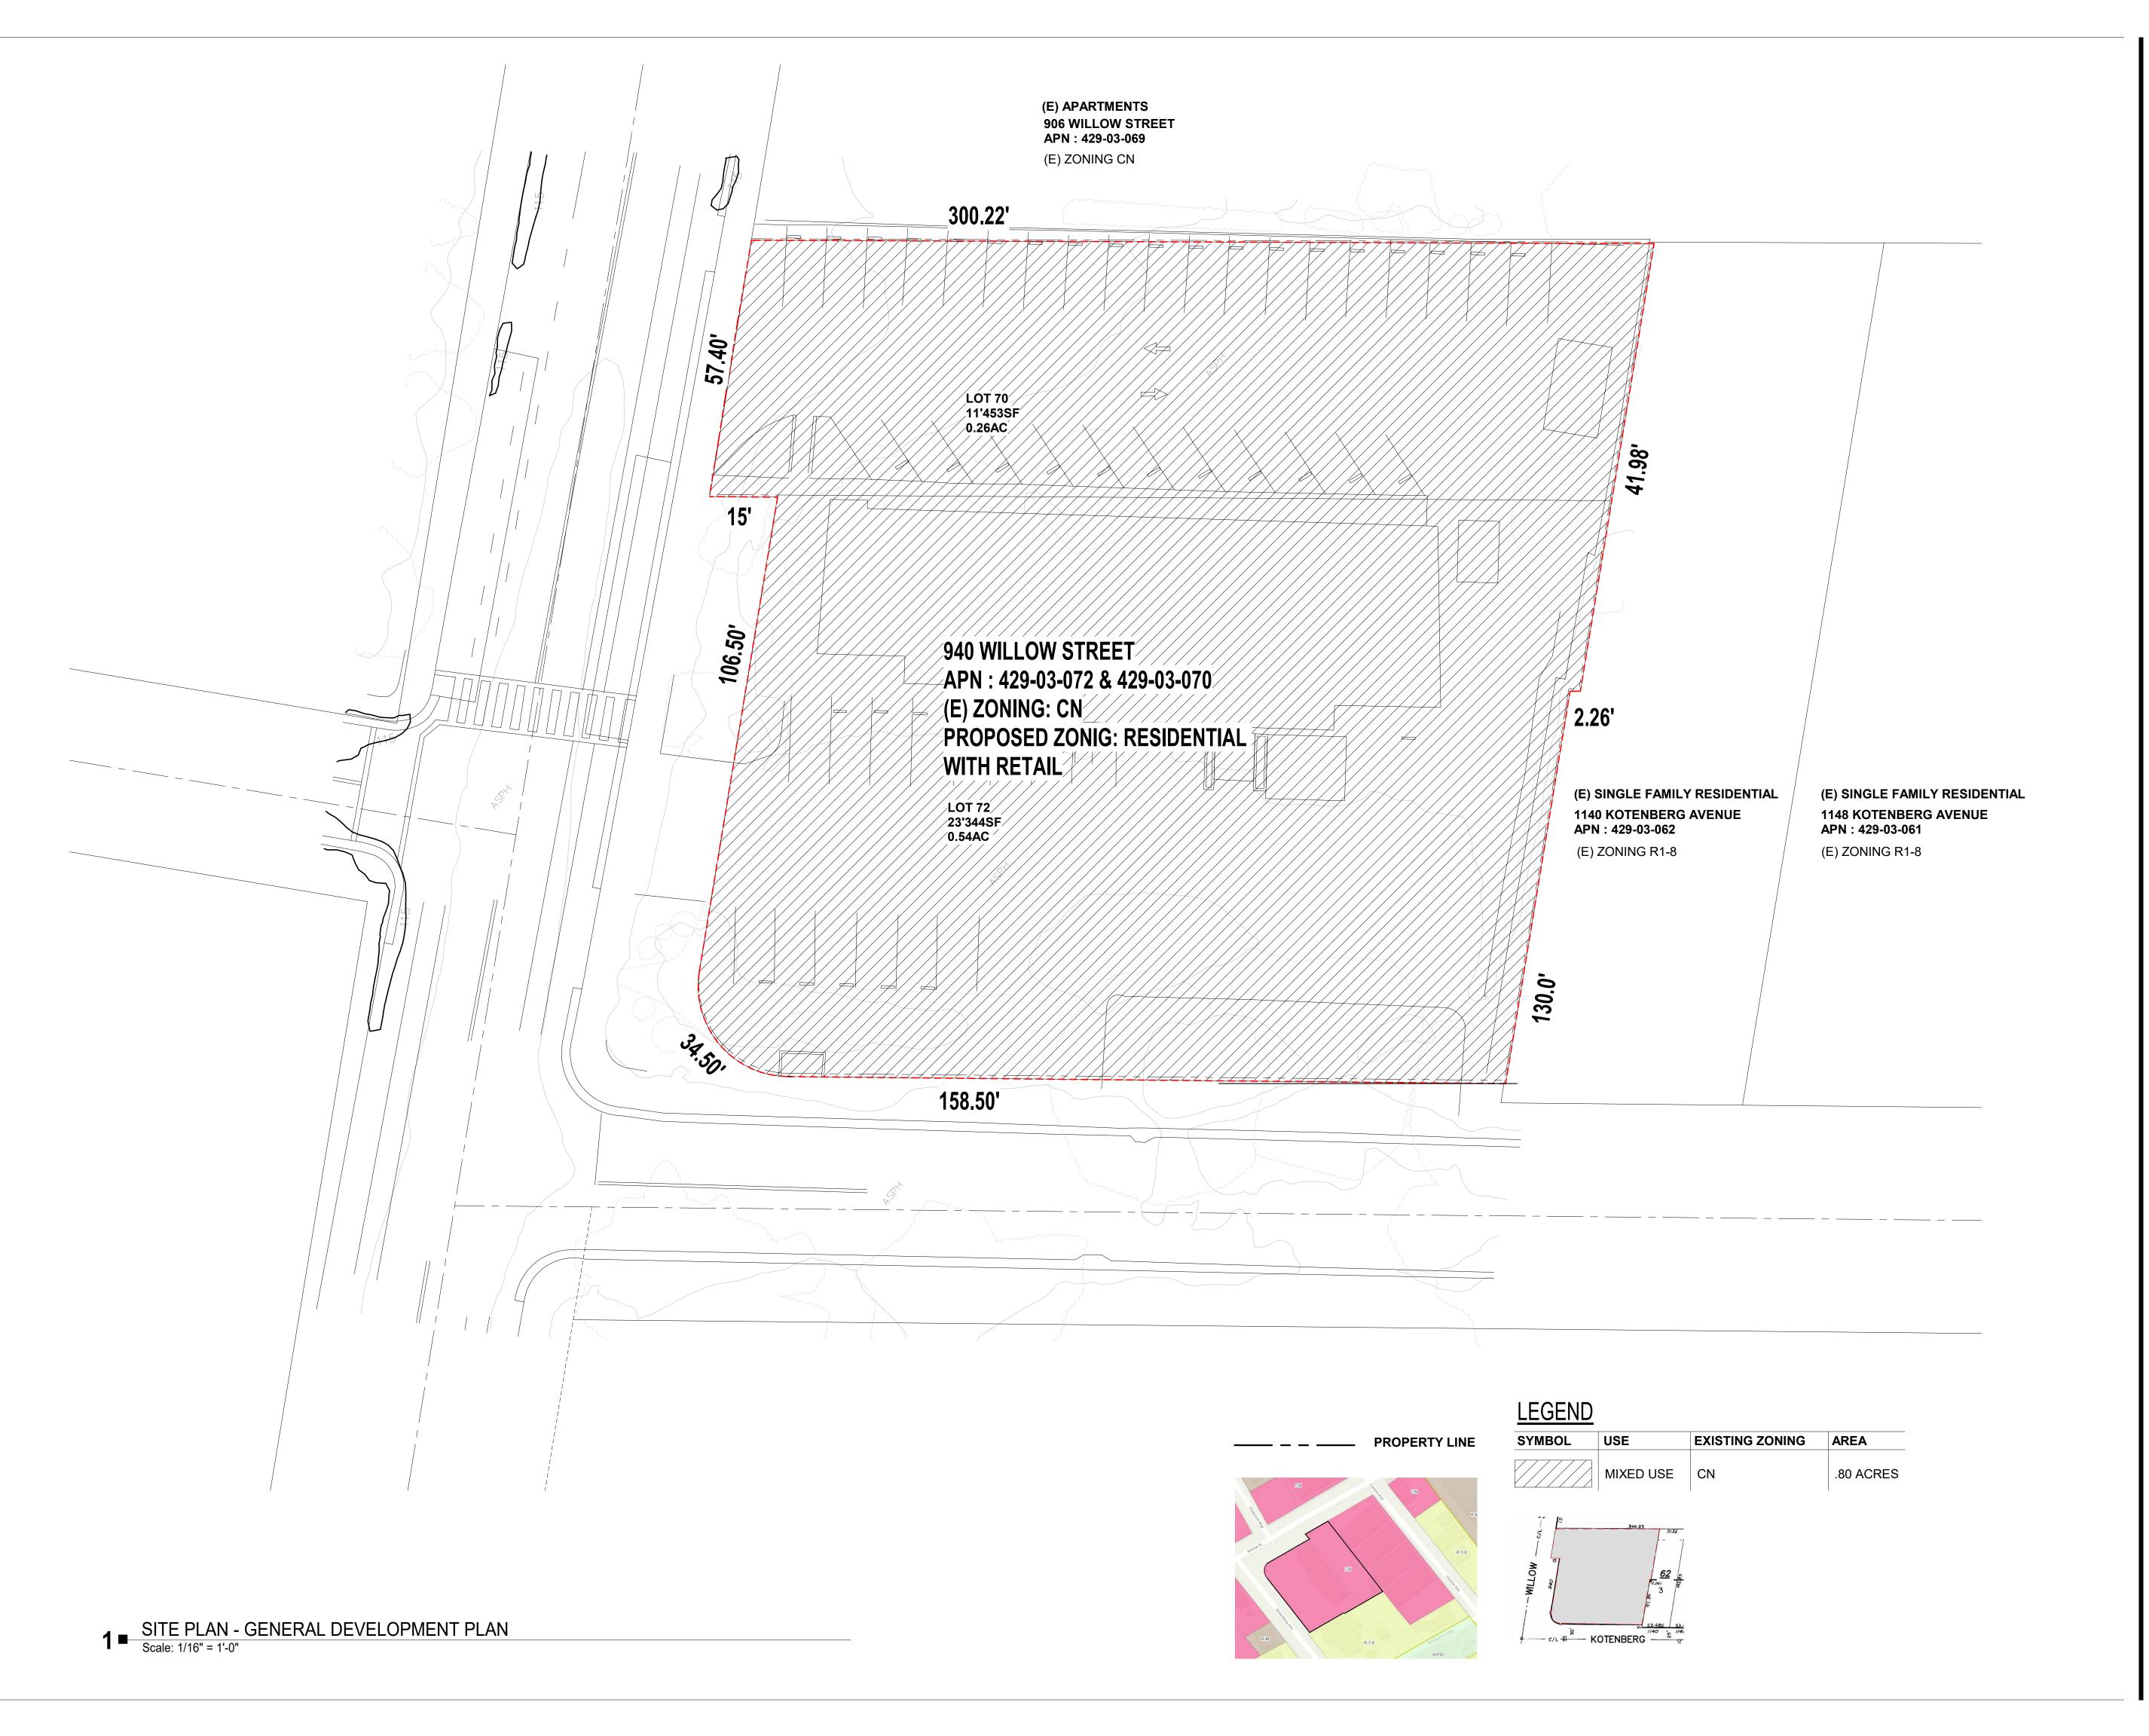
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GENERAL DEVELOPMENT PLAN

004-G



VIEW 4: FROM KOTENBERG AVE.

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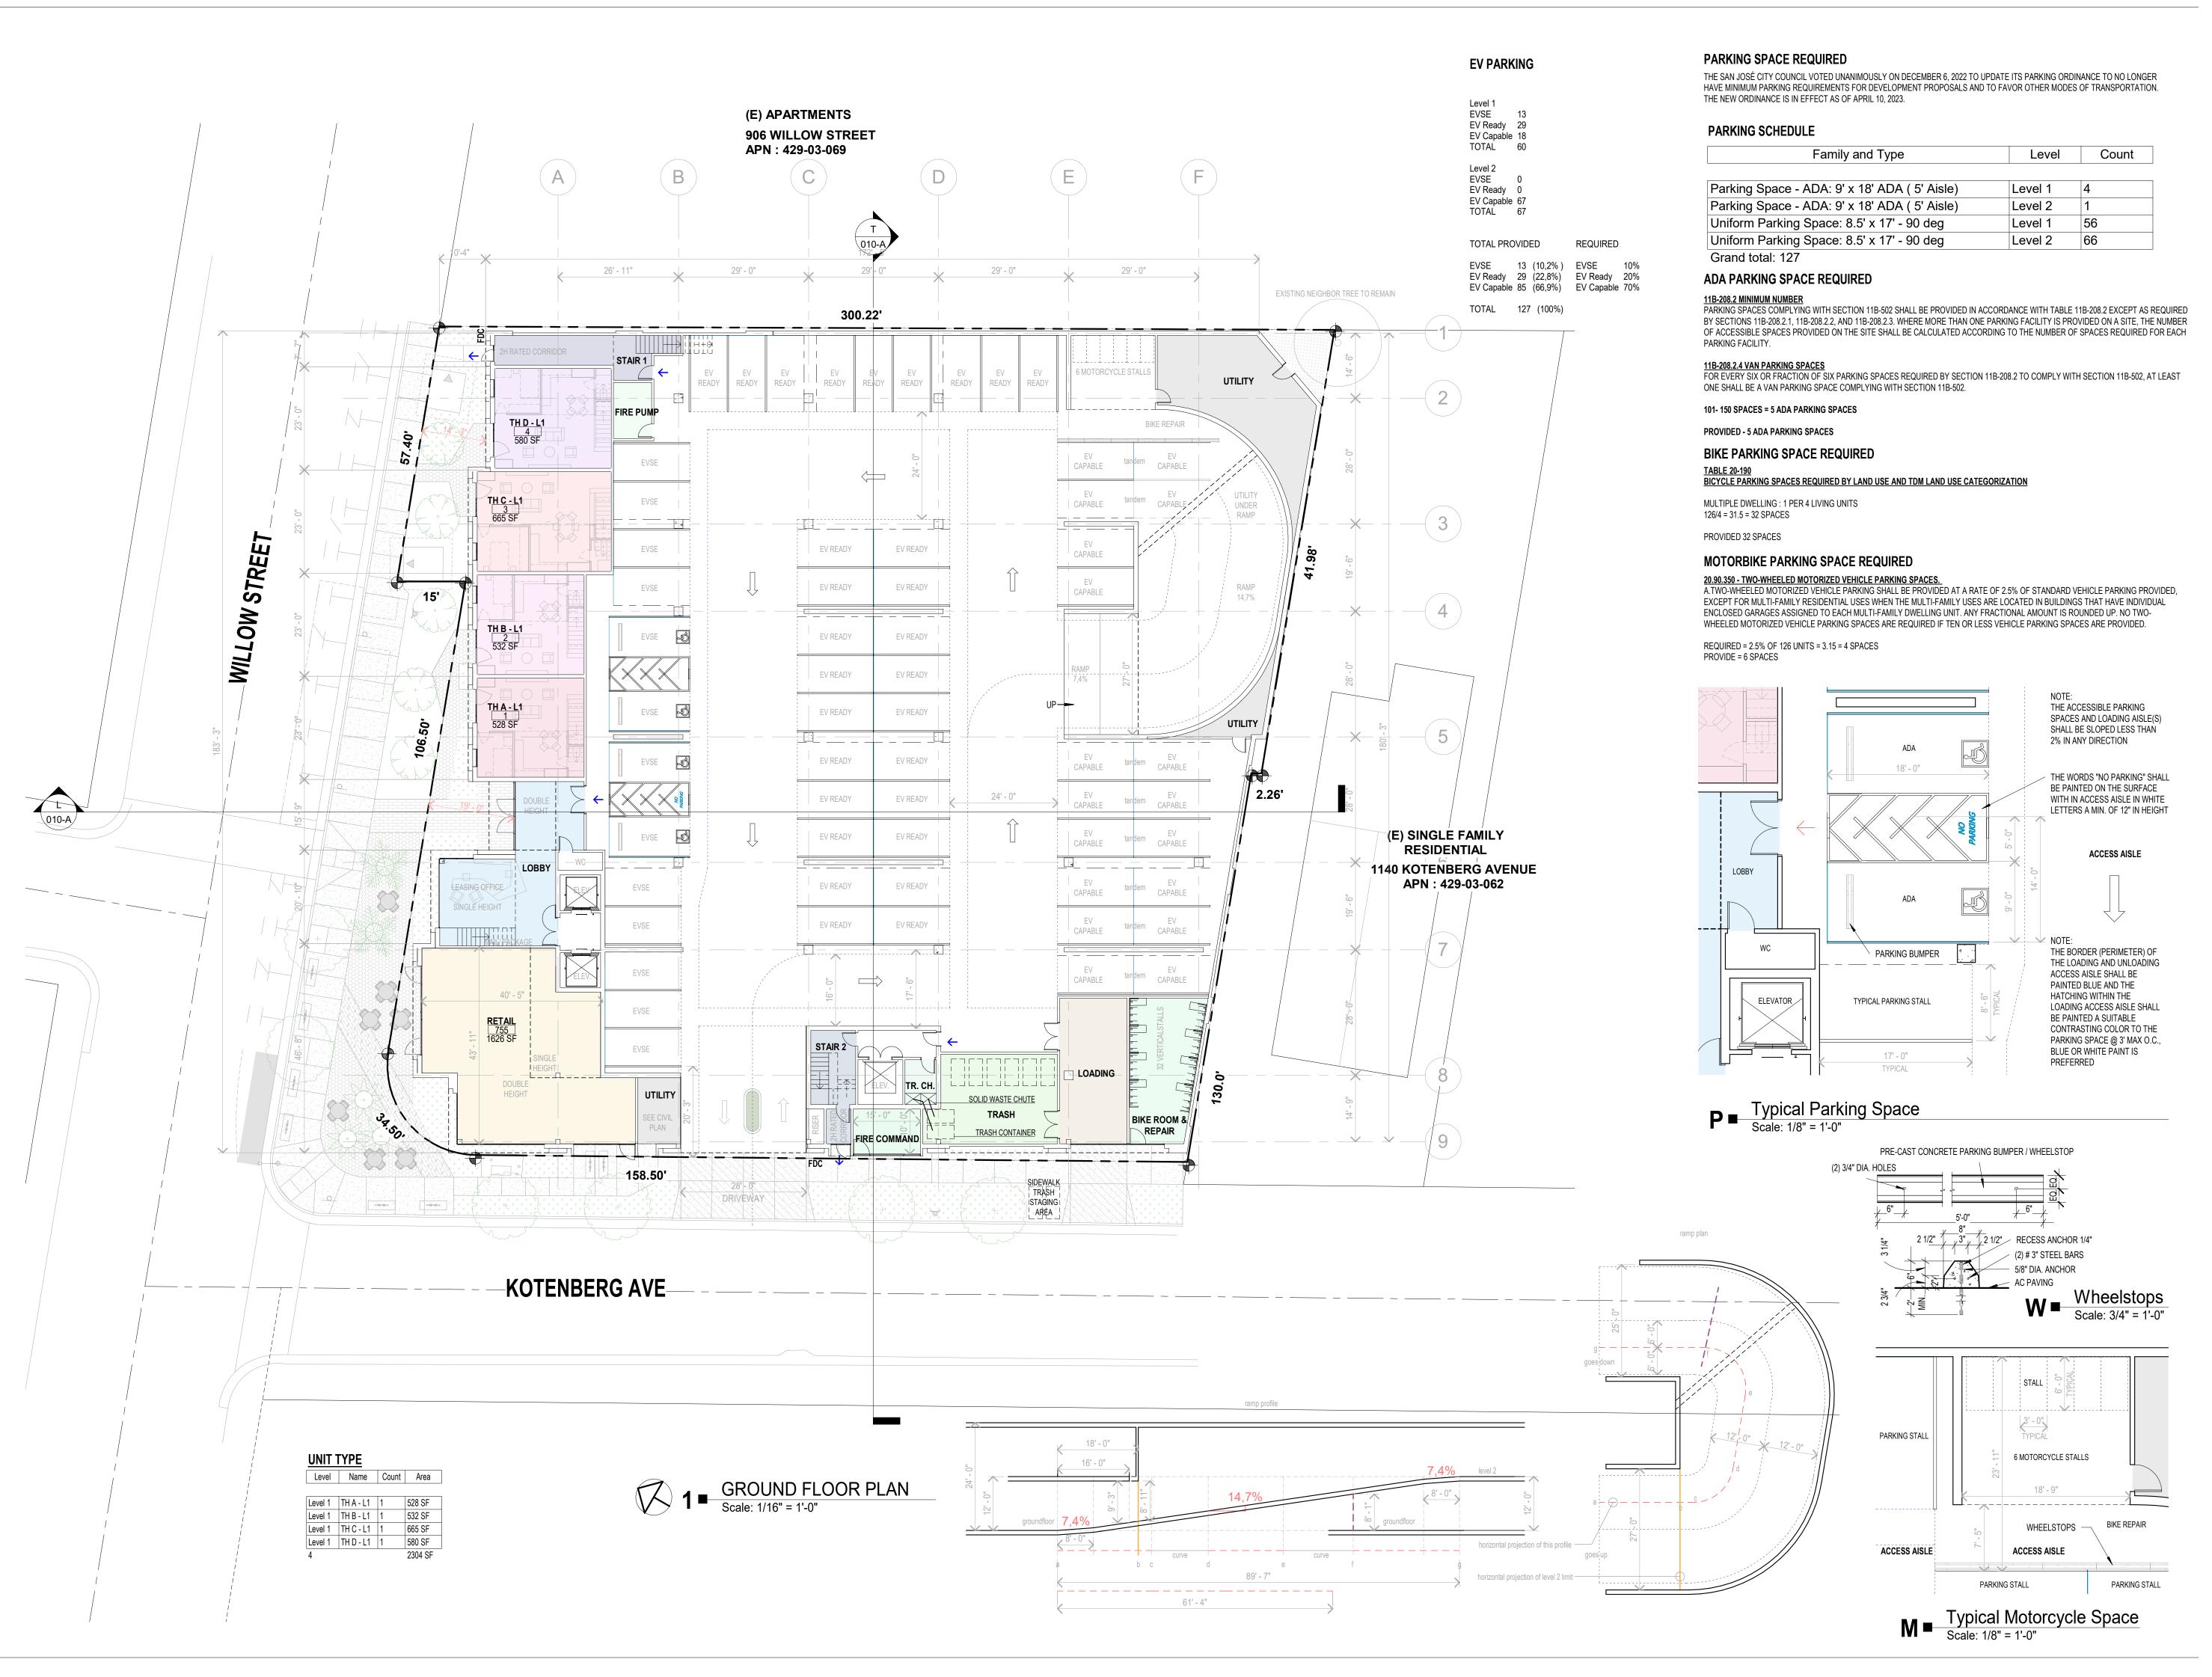


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EXISTING SITE PLAN & PHOTOS

005-F





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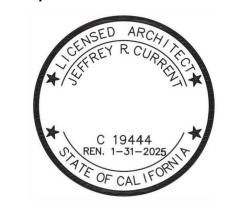
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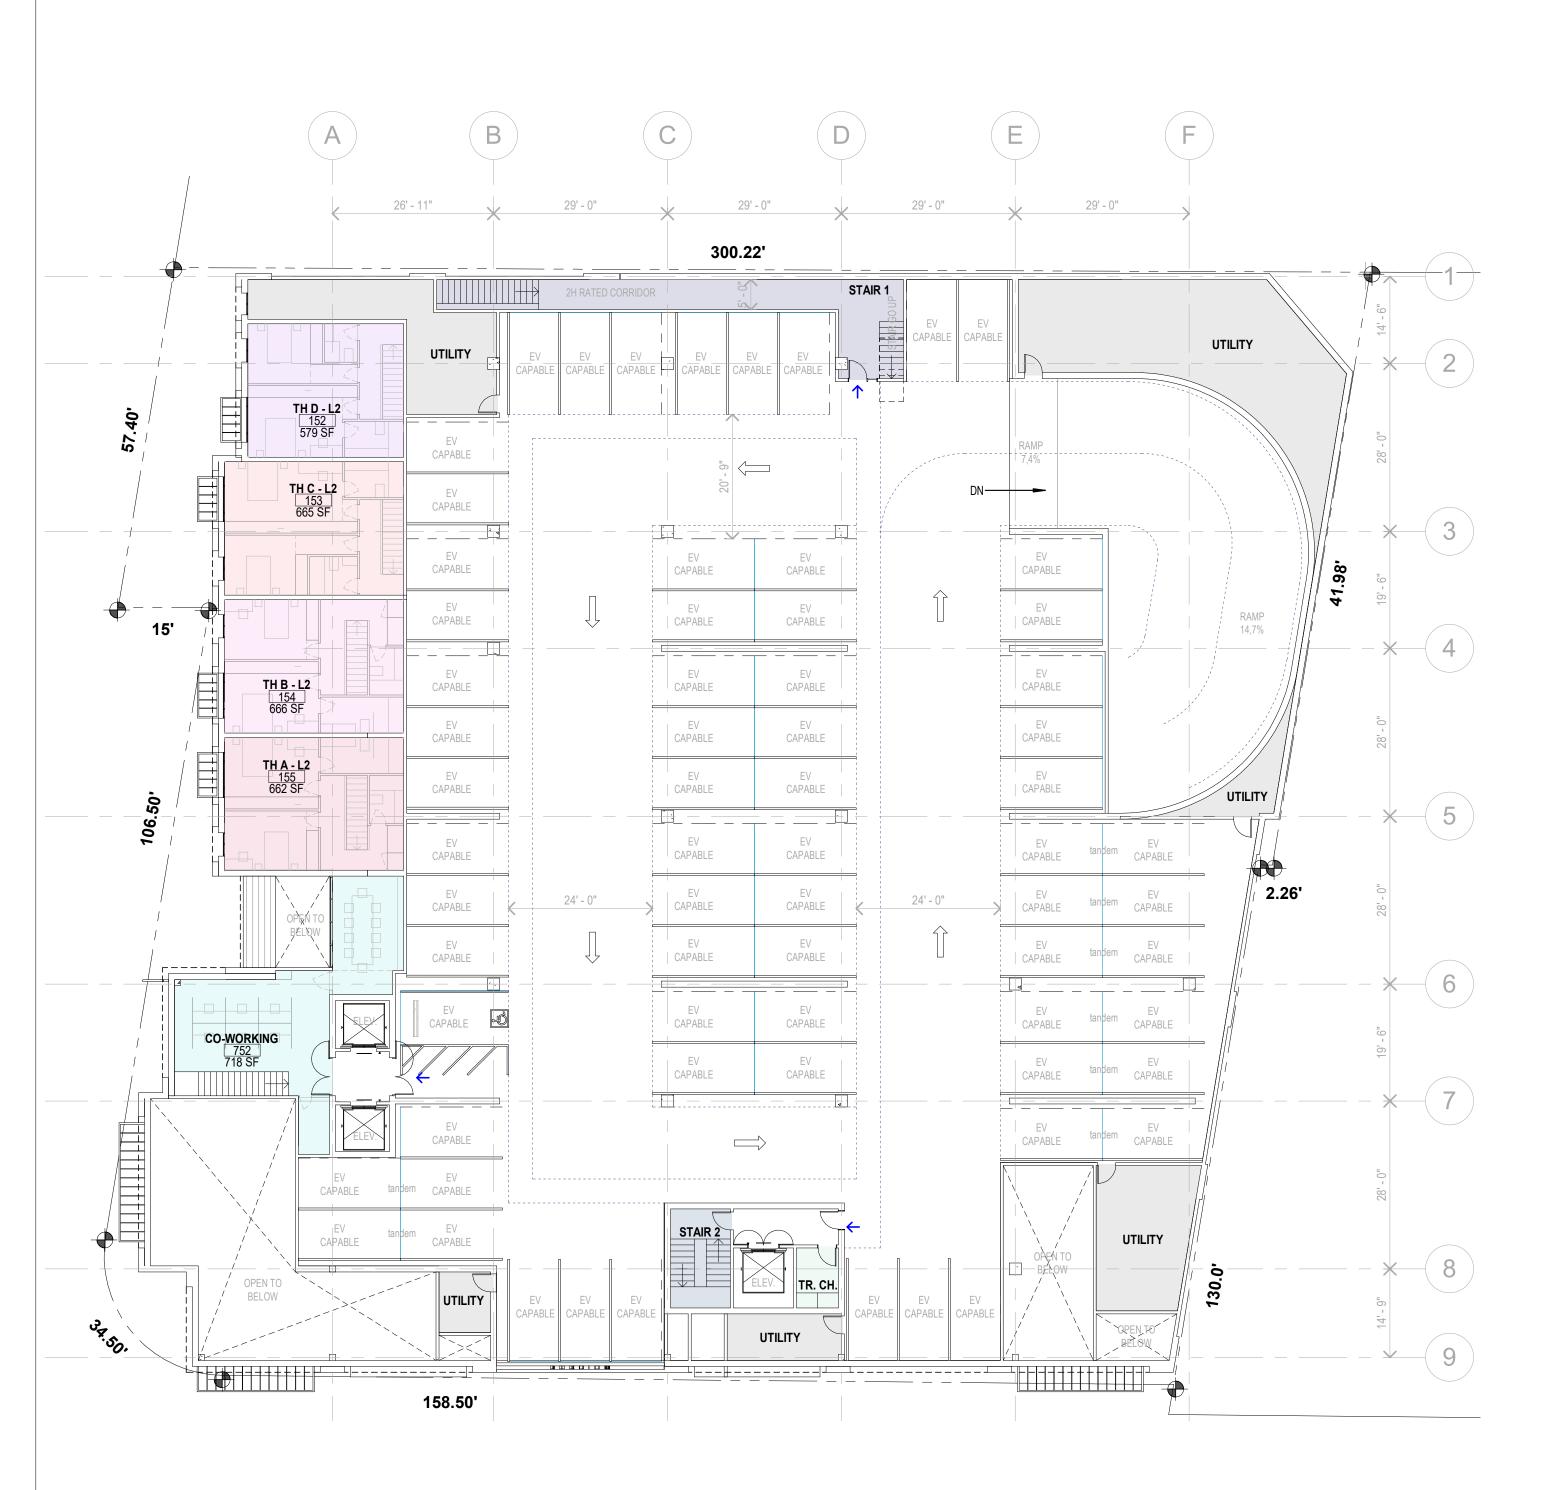


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PROPOSED GROUND FLOOR & SITE PLAN

006-S







UNIT TYPE			
Level	Name	Count	Area
Level 2	TH D - L2	1	579 SF
Level 2	TH C - L2	1	665 SF
Level 2	TH A - L2	1	662 SF
Level 2	TH B - L2	1	666 SF
Grand tota	1: 4		2572 SF



3 = LEVEL 3 (PODIUM PLAN)
Scale: 1/16" = 1'-0"

UNIT 1	UNIT TYPE			
Level	Name	Count	Area	
Level 3	1 BDR	10	6577 SF	
Level 3	2 BDR	4	3258 SF	
Level 3	ST	10	5089 SF	
24			14923 SF	

PRIVATE OPEN SPACE

	T	
Level	Name	Area
Level 3	Private Open Space	1243 SF
Level 4	Private Open Space	517 SF
Level 5	Private Open Space	575 SF
Level 6	Private Open Space	3007 SF
		5343 SF

REQUIRED = STUDIO & 1 BDR = 102 X 30 = 3,060 SF = 2 BDR = 21 X 45 = 945 SF TOTAL REQUIRED = 3,060+ 945 = 4,005 SF



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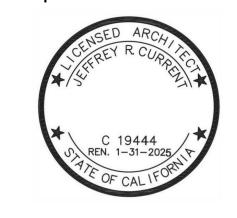
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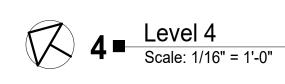


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LEVEL 2 & 3 FLOOR PLAN





Level Name Count Area

Level 4	1 BDR	10	6573 SF
Level 4	2 BDR	6	4893 SF
Level 4	ST	9	4580 SF
25			16047 SE





Level Name Count Area Level 5 1 BDR 10 6562 SF Level 5 2 BDR 7 5695 SF Level 5 ST 9 4580 SF 26 16837 SF

PRIVATE OPEN SPACE

Level	Name	Area
Level 3	Private Open Space	1243 SF
Level 4	Private Open Space	517 SF
Level 5	Private Open Space	575 SF
Level 6	Private Open Space	3007 SF
		5343 SF

REQUIRED = STUDIO & 1 BDR = 102 X 30 = 3,060 SF = 2 BDR = 21 X 45 = 945 SF TOTAL REQUIRED = 3,060+ 945 = 4,005 SF



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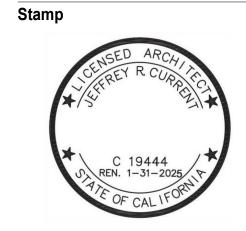
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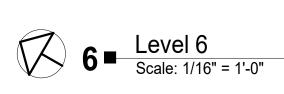
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LEVEL 4 & 5 FLOOR PLAN


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UNIT	TYPE		
Level	Name	Count	Area
Level 6	1 BDR	11	6863 SF
Level 6	2 BDR	1	851 SF
Level 6	ST	12	5396 SF
24	•		13109 SF





UNIT	TYPE		
Level	Name	Count	Area
Level 7	1 BDR	9	5520 SF
Level 7	2 BDR	2	1732 SF
Level 7	ST	12	5396 SF
23			12648 S

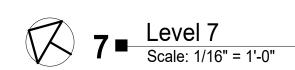PRIVATE OPEN SPACE

Level	Name	Area
Level 3	Private Open Space	1243 SF
Level 4	Private Open Space	517 SF
Level 5	Private Open Space	575 SF
Level 6	Private Open Space	3007 SF
		5343 SF

REQUIRED = STUDIO & 1 BDR = 102 X 30 = 3,060 SF = 2 BDR = 21 X 45 = 945 SF TOTAL REQUIRED = 3,060+ 945 = 4,005 SF



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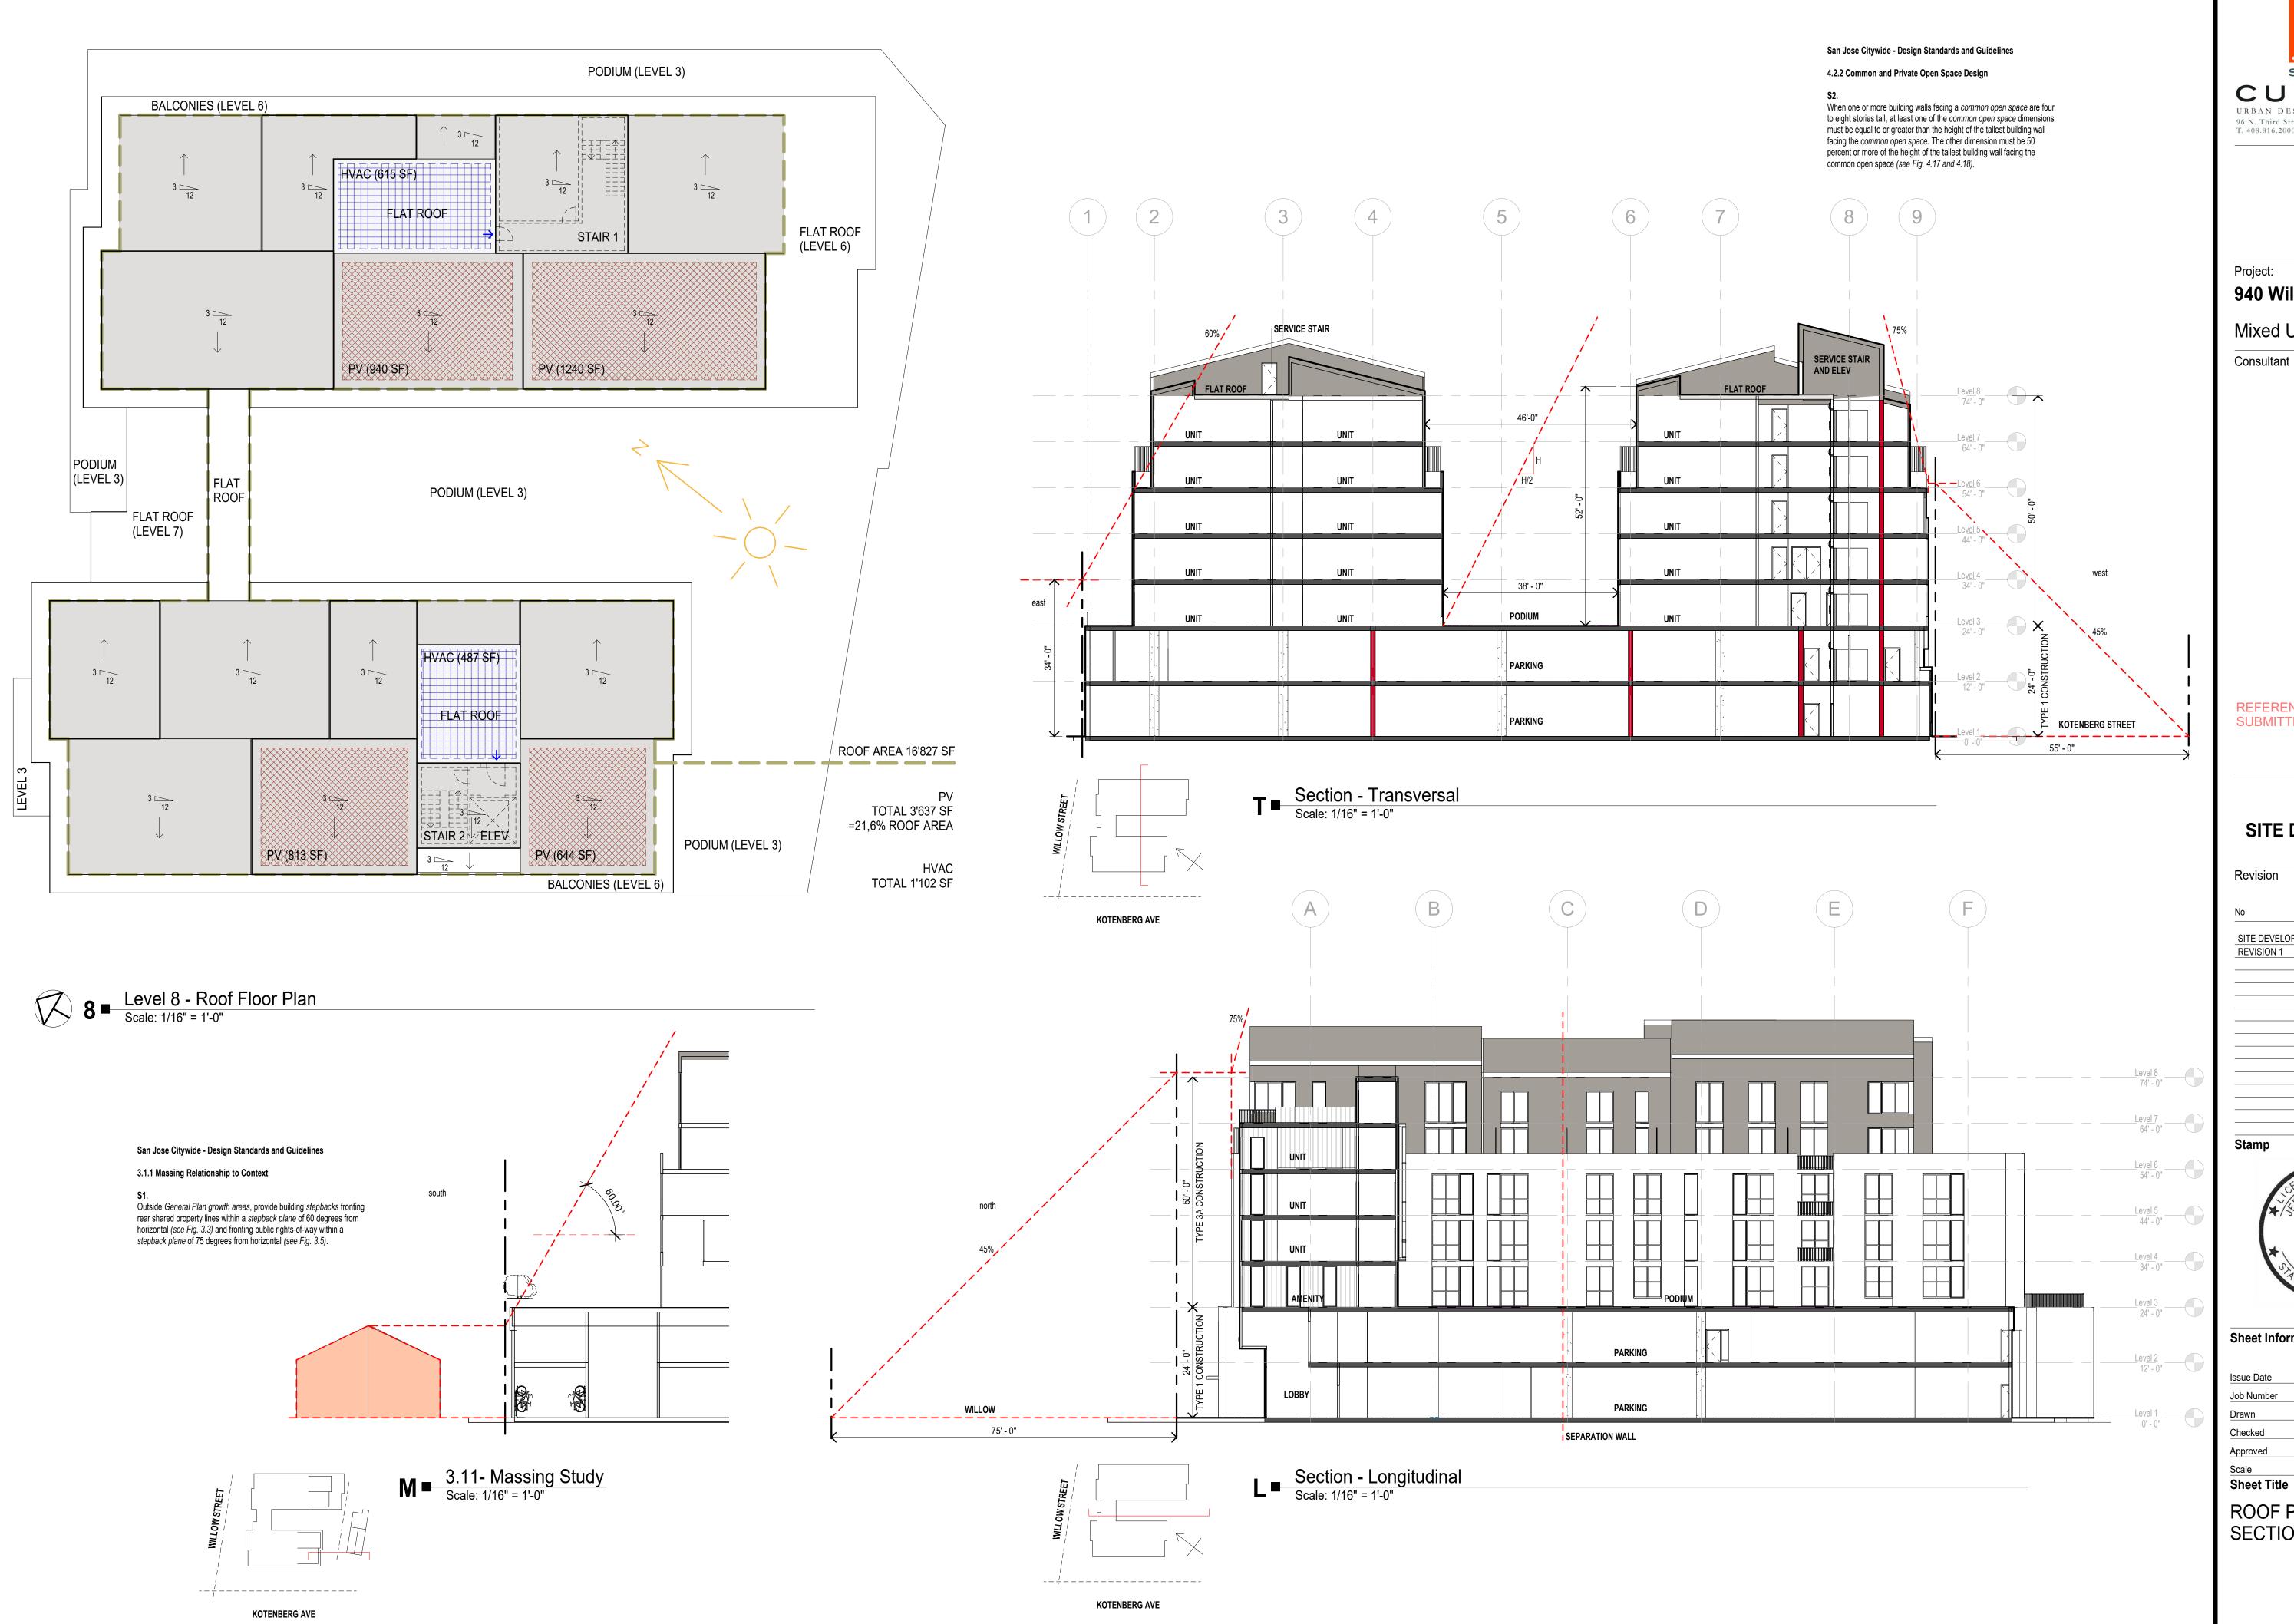
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LEVEL 6 & 7 FLOOR PLAN



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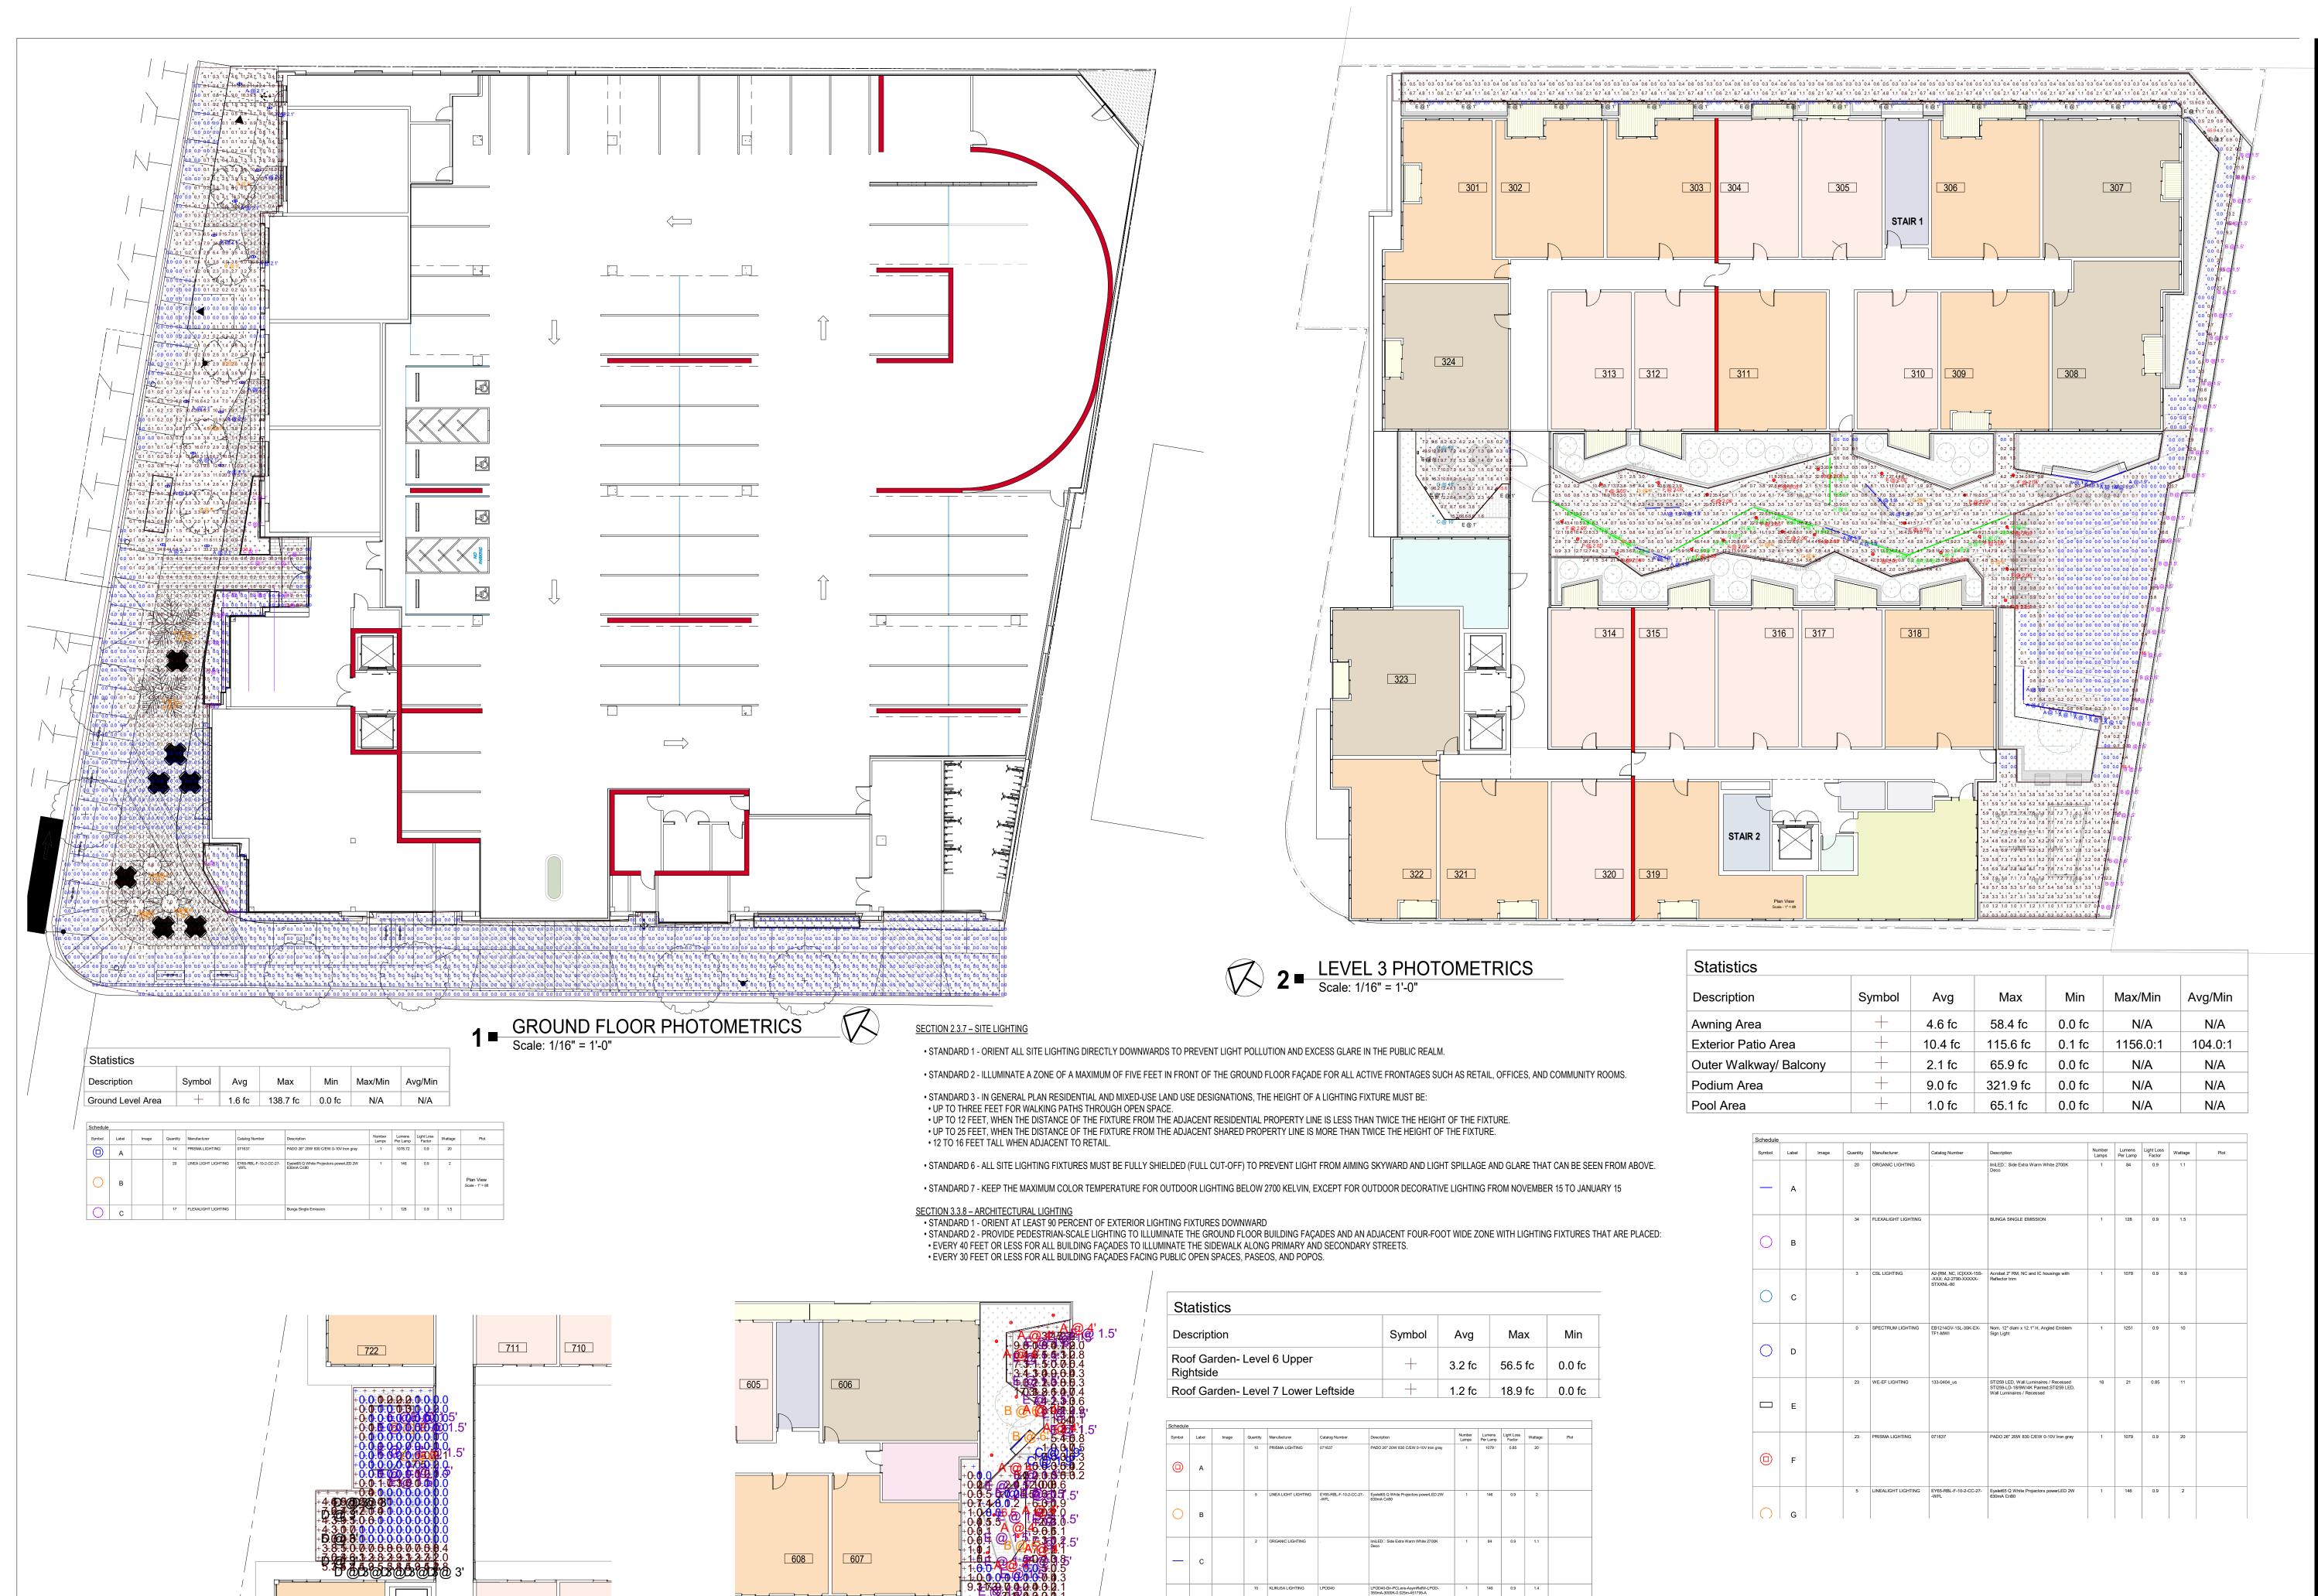
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ROOF PLAN & SECTIONS



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721

Level 7 PHOTOMETRICS

712

713

Level 6 PHOTOMETRICS



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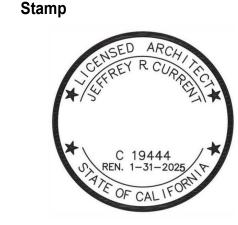
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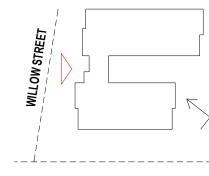
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LIGHTING PLAN




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KOTENBERG AVE



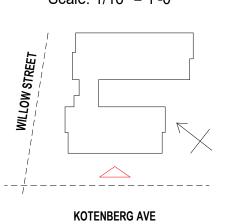2 Scale: 1/16" = 1'-0"







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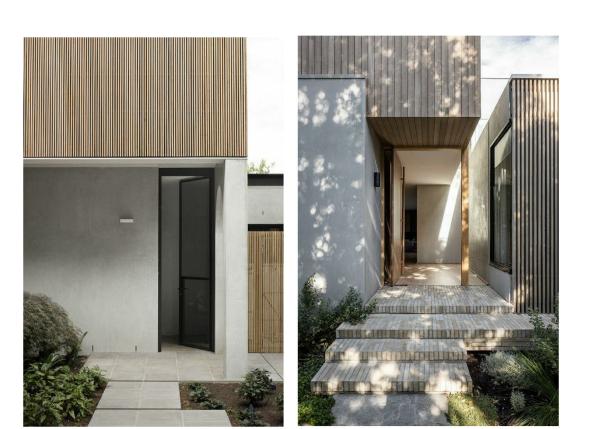
THE WHITE BRICK BASE - STOREFRONT







THE WHITE BRICK BASE - RESIDENTIAL INFLUENCE



THE STUCCO & WOOD PANNELING - INFLUENCE







THE FACADE AND ROOF INSPIRATION



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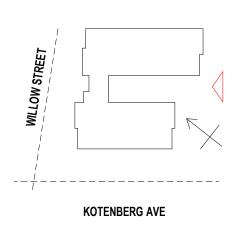
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EXTERIOR ELEVATIONS



3 Elevation South-East Scale: 1/16" = 1'-0"



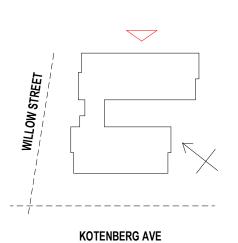


METAL PANEL STUCCO - DECORATIVE WOOD PANELS

WHITE BRICK

BIRD SAFETY GLAZING WHERE REQUIRED

4 Elevation North-East Scale: 1/16" = 1'-0"







THE WHITE BRICK BASE - STOREFRONT



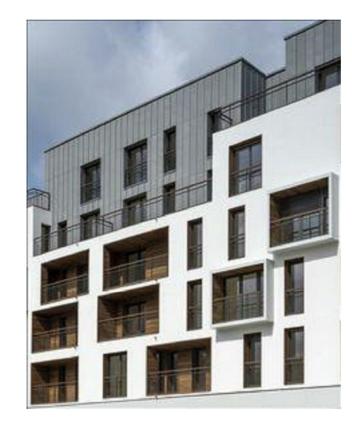




THE WHITE BRICK BASE - RESIDENTIAL INFLUENCE



THE STUCCO & WOOD PANNELING - INFLUENCE







THE FACADE AND ROOF INSPIRATION



940 Willow Street

Mixed Use Proposal

Consultant

REFERENCE FILE # PRE23-089 SUBMITTED ON JUNE 12, 2023

H23-030 SITE DEVELOPMENT PERMIT

Revision

No	Date
SITE DEVELOPMENT	10.05.2023
REVISION 1	12.01.2023



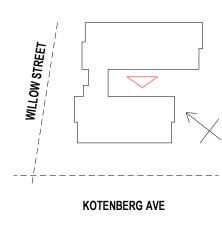
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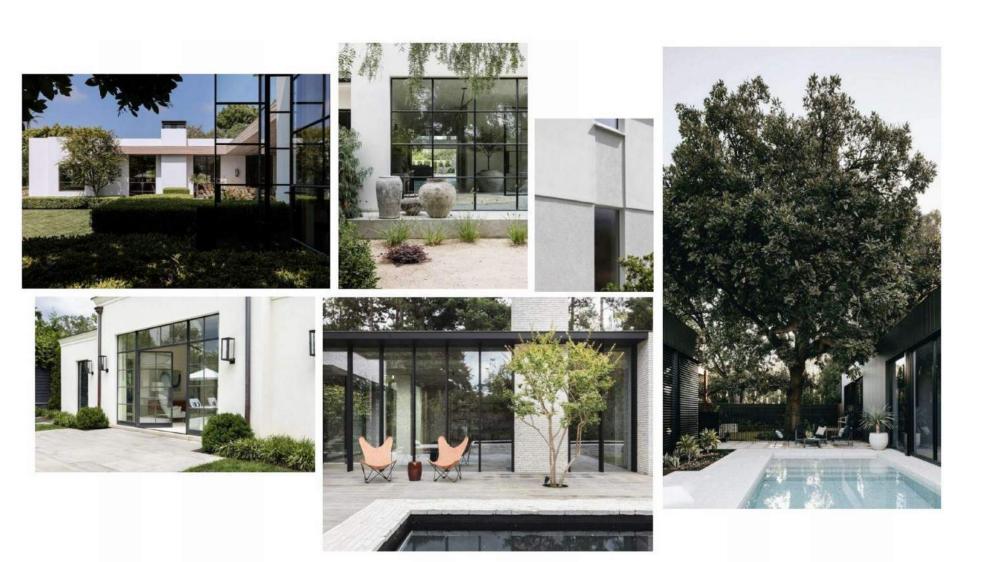
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Scale	1/16" = 1'-0
Sheet Title	

EXTERIOR ELEVATIONS



1 COURTYARD ELEVATION North-East
Scale: 1/16" = 1'-0"





THE LANDSCAPE - INFLUENCE



THE LANDSCAPE - INFLUENCE



KOTENBERG AVE



3 COURTYARD ELEVATION South-West
Scale: 1/16" = 1'-0"

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Revision

 No
 Date

 SITE DEVELOPMENT
 10.05.2023

Stamp



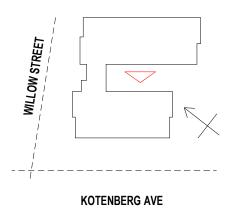
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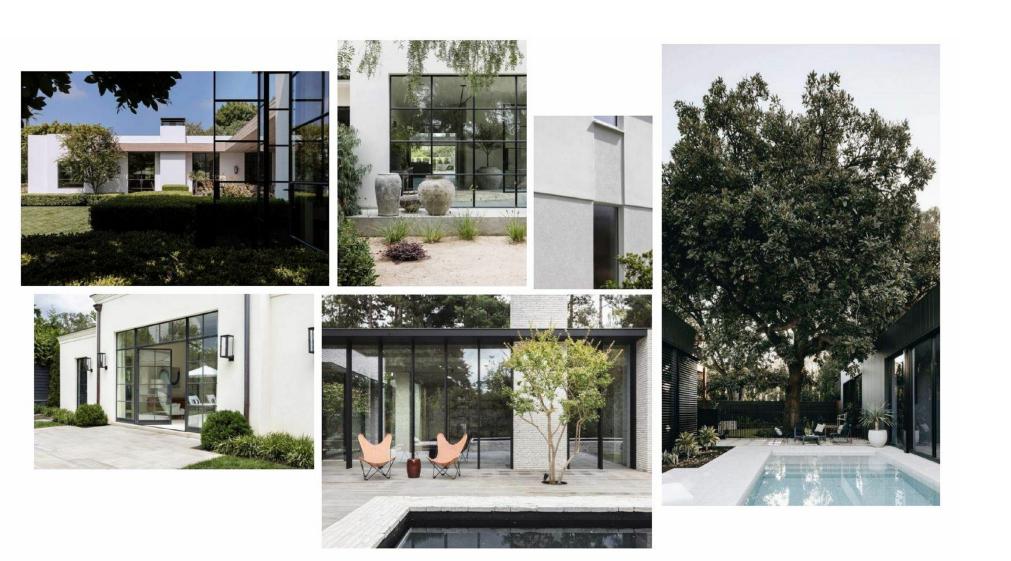
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Approved	Designer
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Shoot Title	

EXTERIOR ELEVATIONS



1 COURTYARD ELEVATION North-East
Scale: 1/16" = 1'-0"

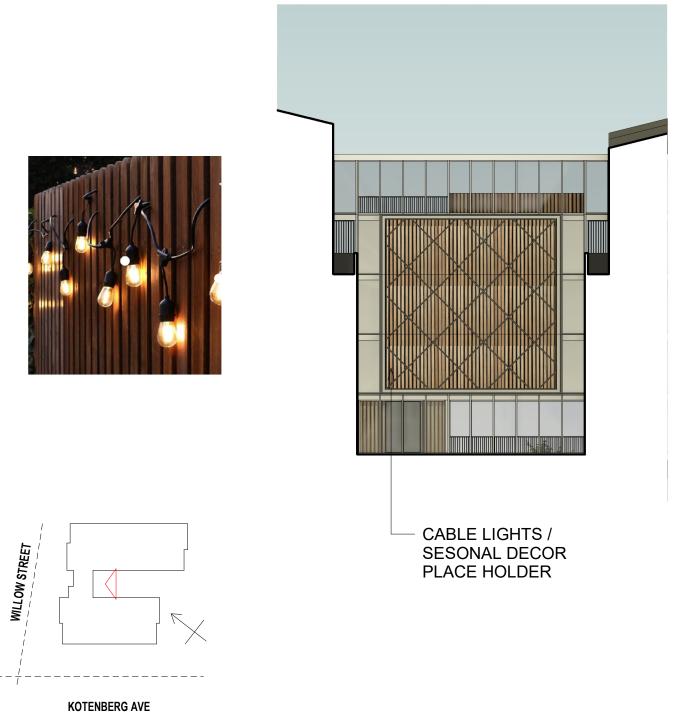




THE LANDSCAPE - INFLUENCE



THE LANDSCAPE - INFLUENCE



2 COURTYARD Elevation South-East
Scale: 1/16" = 1'-0"



3 COURTYARD ELEVATION South-West
Scale: 1/16" = 1'-0"

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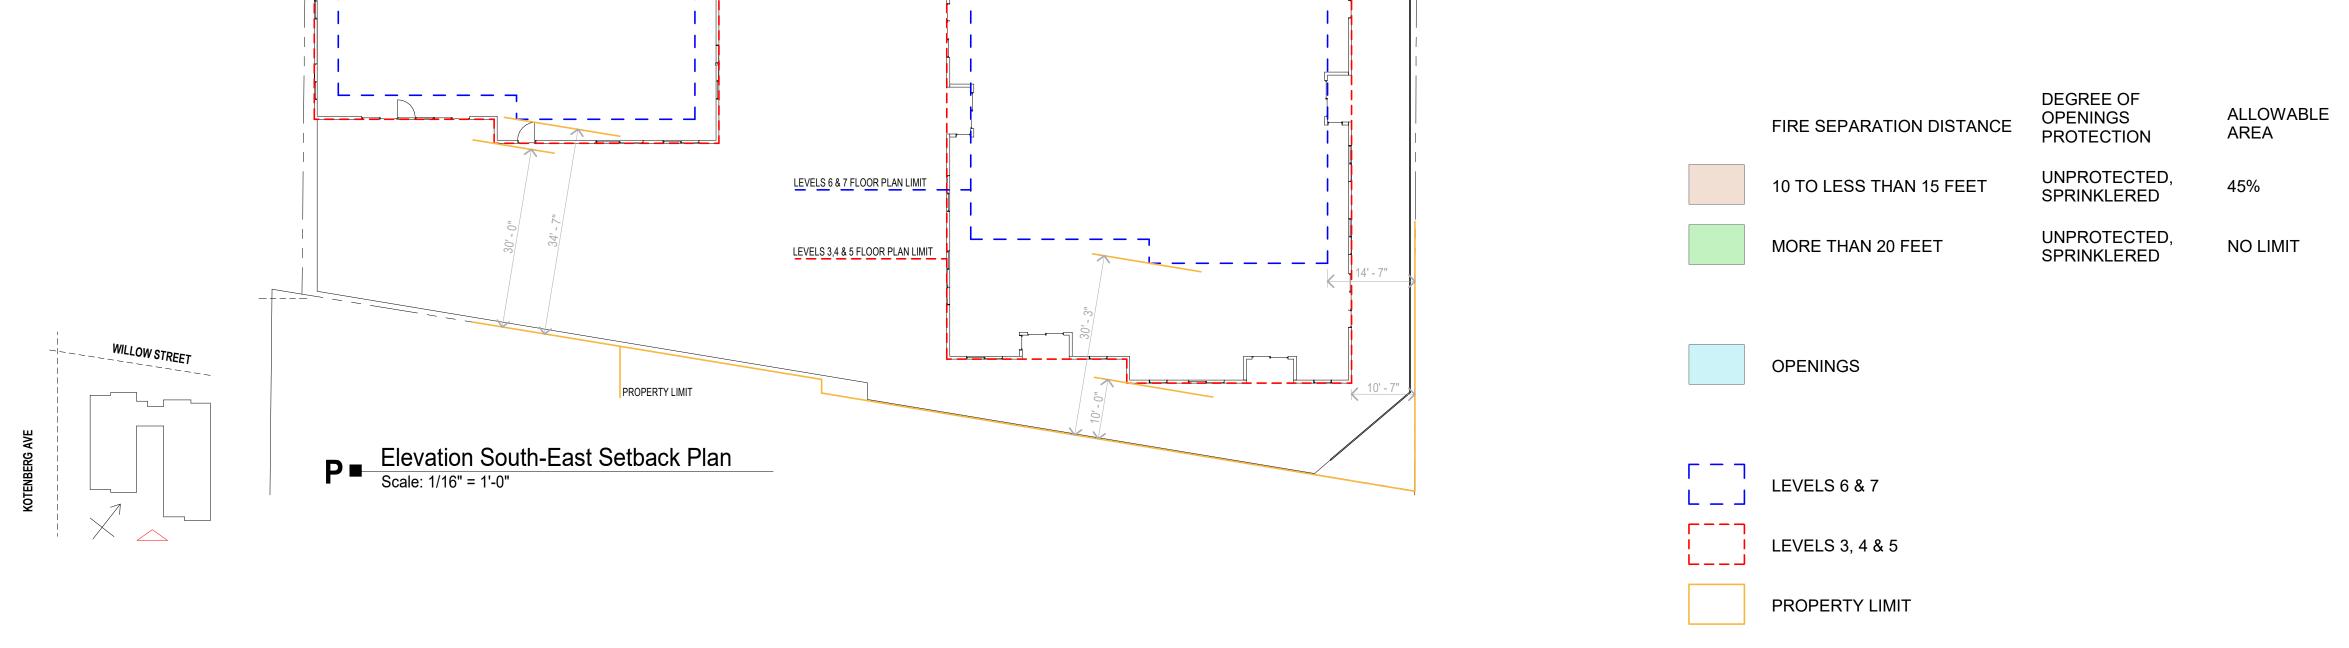


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EXTERIOR ELEVATIONS









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Scale	1/16" = 1'-0"
Sheet Title	

OPENINGS ANALYSIS

014R-A

KOTENBERG AVE

KOTENBERG AVE



- WHITE BRICK

BIRD SAFETY GLAZING WHERE REQUIRED

DECORATIVE WOOD PANELS

2 Scale: 1/16" = 1'-0"

KOTENBERG AVENUE - Elevation Analysis

KOTENBERG AVE

- METAL PANEL

— STUCCO

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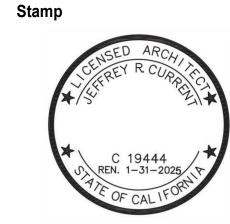
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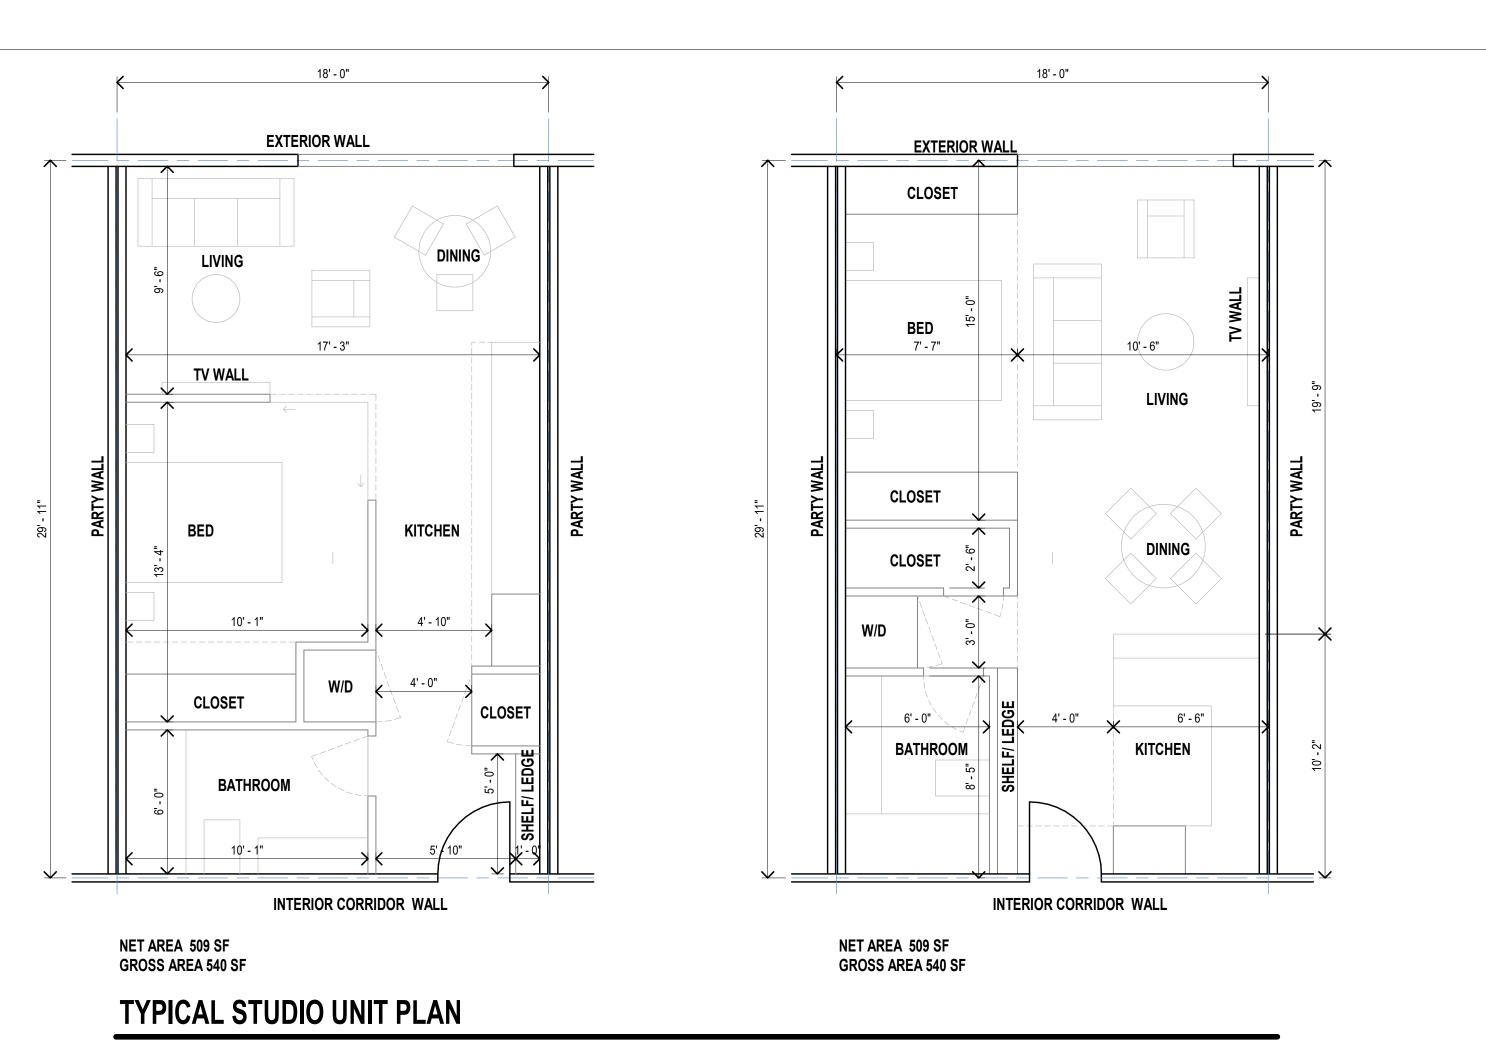
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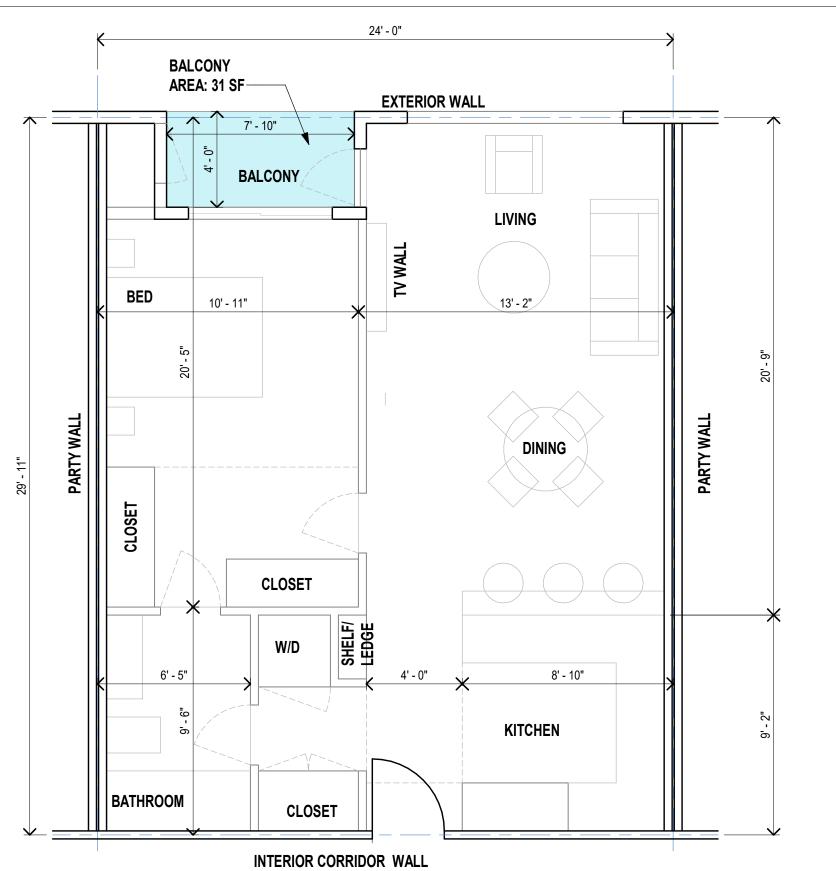
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Sheet Title	

ELEVATIONS ANALYSIS

014C-A

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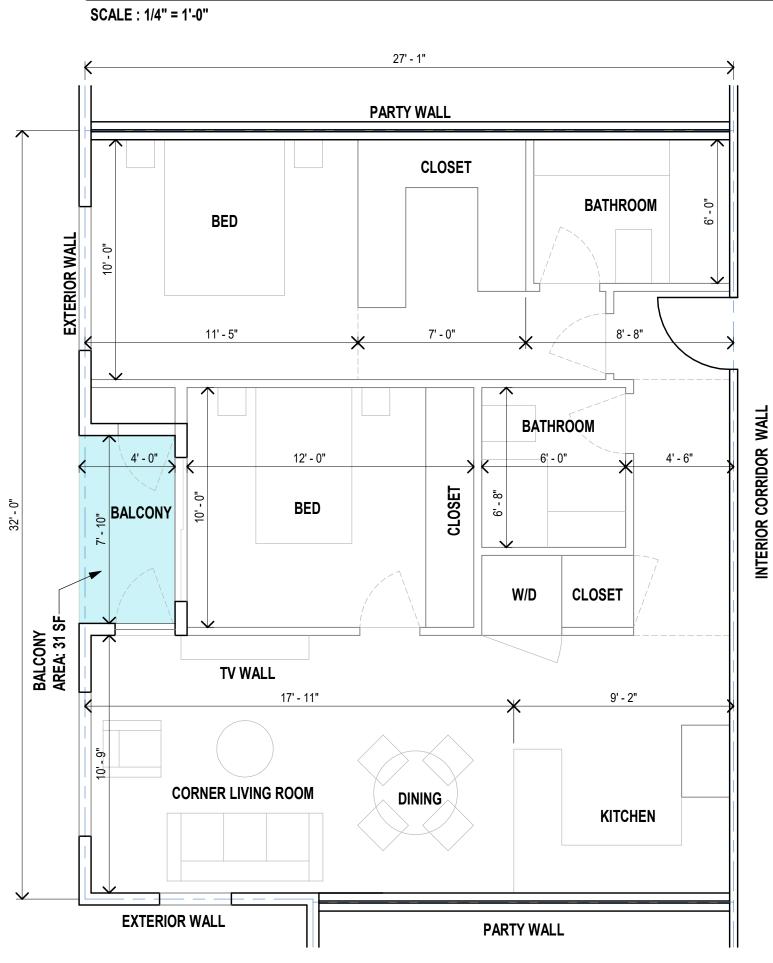





NET AREA 686 SF GROSS AREA 720 SF

TYPICAL 1 BED UNIT PLAN

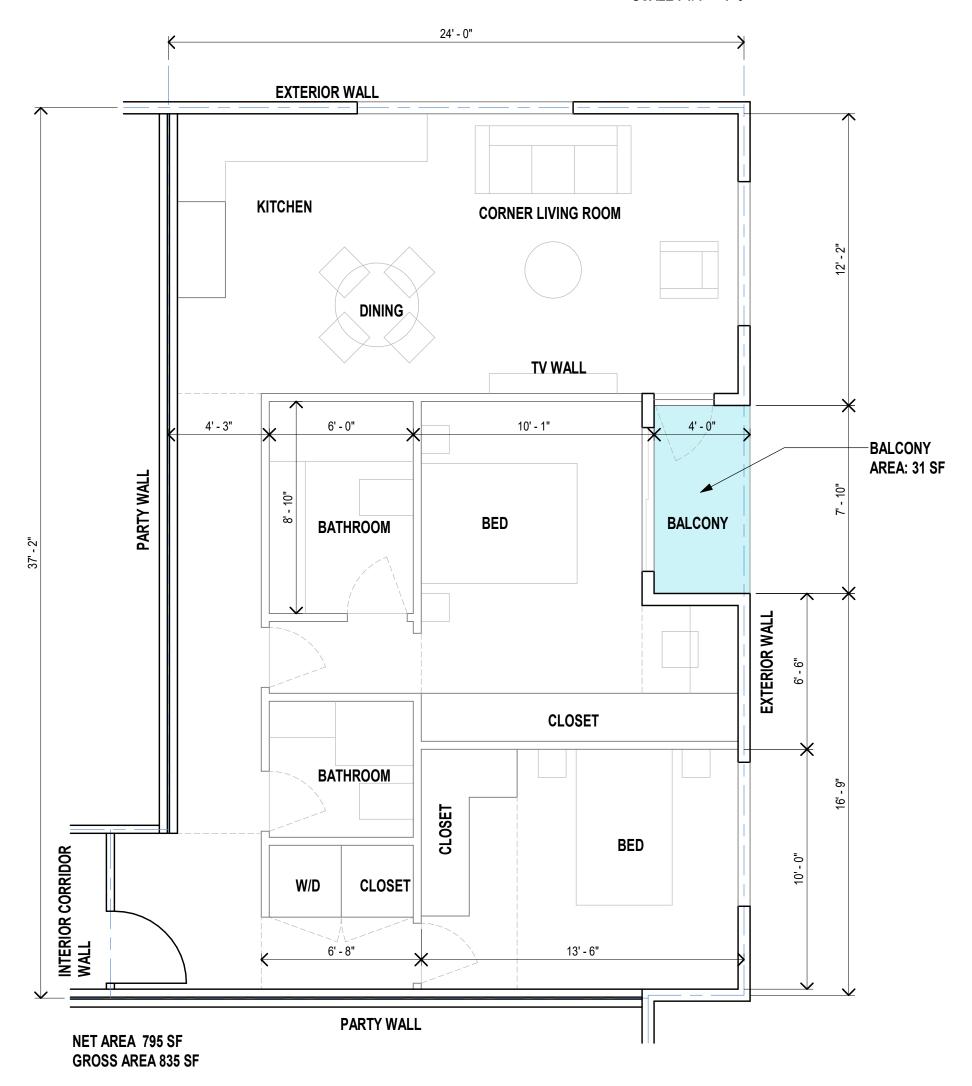SCALE : 1/4" = 1'-0"





TYPICAL 2 BED UNIT PLAN

SCALE : 1/4" = 1'-0"

NET AREA 761 SF GROSS AREA 801 SF

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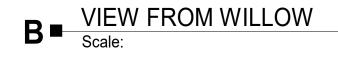
TYPICAL UNIT LAYOUT





VIEW FROM WILLOW LOOKING TOWARDS KOTENBERG

Scale:





C = VIEW @ CORNER OF WILLOW AND KOTENBERG

Scale:



VIEW FROM KOTENBERG LOOKING TOWARDS WILLOW

Scale:



Project:

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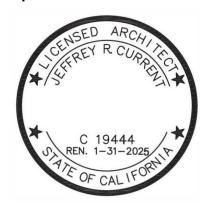
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Scale	

PROPOSED BUILDING 3D PERSPECTIVES



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1 WILLOW STREET ELEVATION- SIGNAGE
Scale: 1/4" = 1'-0"

3 SECTION SHOWING FIN SIGN
Scale: 1/8" = 1'-0"



INTENDI

TYPE 4

FIN SIGN - (TENANT SIGN) A TWO SIDED SIGN INTENDED TO BE VIEWED FROM SIDE

TYPE 2
TENANT SIGN


TYPE 1

FLAT MOUNTED SIGN - SIGN MOUNTED FLUSH OR PARALLEL TO THE SURFACE OF BUILDING FACADE



TYPE 1 (SIGNAGE BACKLIT)

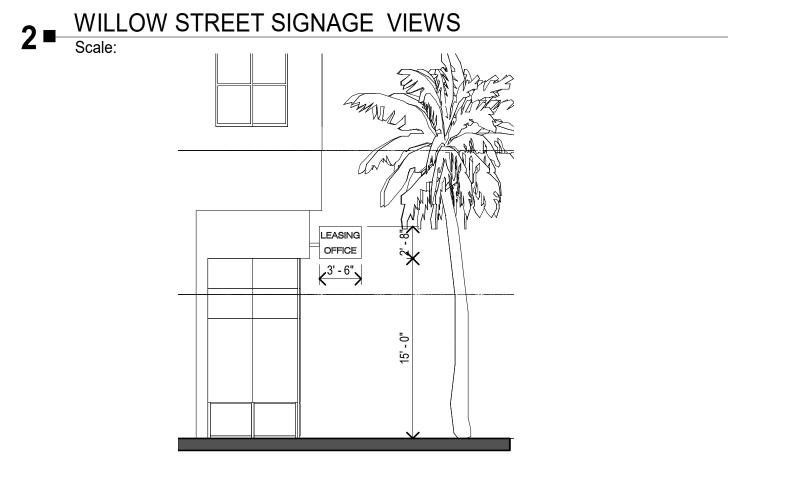TYPE 2





STARBUCKS

K ST S.

WETSON

AUTONIATIA

TYPE 4

FLAT MOUNTED SIGN - SIGN MOUNTED FLUSH OR PARALLEL TO THE SURFACE OF BUILDING FACADE

4 Scale: 1/4" = 1'-0"

TYPE 3

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Scale	As indicate

SIGNAGE

DEMOLITION LEGEND:

EXISTING BUILDING & APPURTENANCES TO BE REMOVED

REMOVE ALL SHRUBS AND VEGETATION WITHIN THE LIMIT OF WORK (SEE DEMOLITION NOTE 18) REMOVE ALL ASPHALT PAVEMENT, FENCES, ARBORS & + + APPURTENANCES

REMOVE ALL CONCRETE, FENCES, ARBORS &

EXISTING TREE TO BE REMOVED



EXISTING TREE TO BE PROTECTED IN PLACE UNLESS NOTED OTHERWISE (SEE DEMOLITION NOTE 18)

-× × × EXISTING FENCE OR WALL TO BE REMOVED

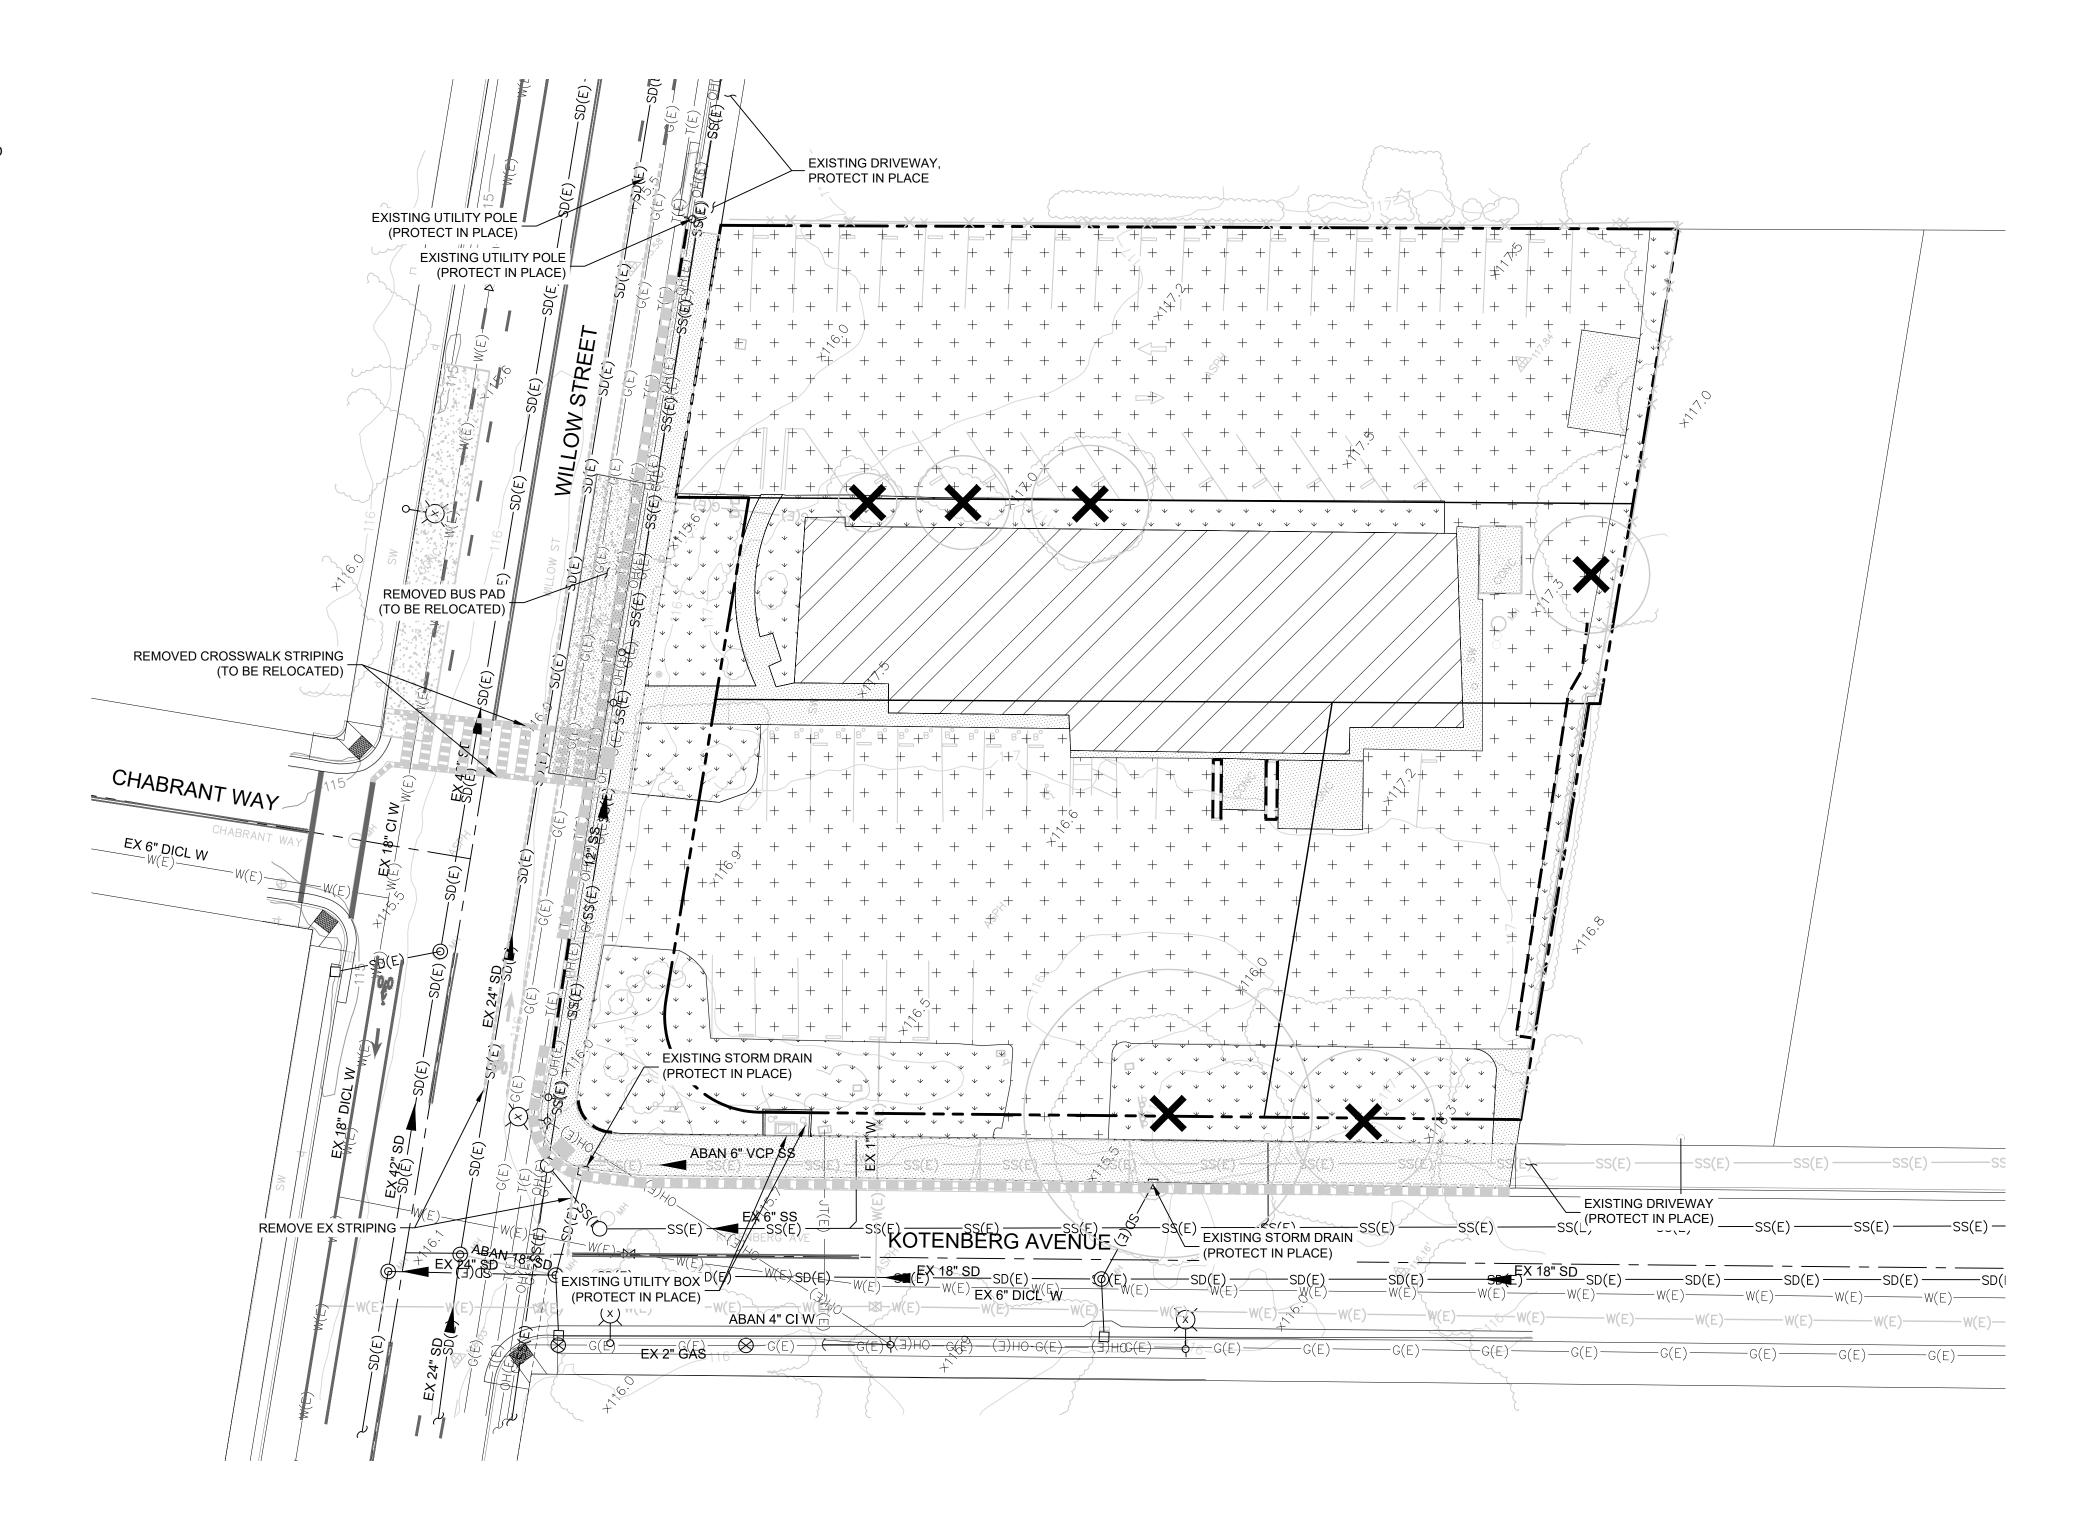
EXISTING STORM DRAIN INLET TO BE REMOVED EXISTING TRANSFORMER TO BE REMOVED

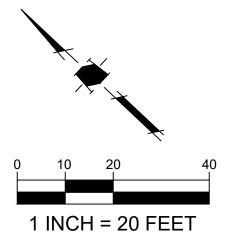
— — — EXISTING CURB TO BE REMOVED

EXISTING CURB & GUTTER TO BE REMOVED

----- SAWCUT LINE — – – SITE BOUNDARY

NOTE: ALL EXISTING UTILITIES LOCATED IN THE PUBLIC RIGHT OF WAY SHOULD BE PROTECTED IN PLACE UNLESS NOTED OTHERWISE.







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PRELIMINARY REVIEW

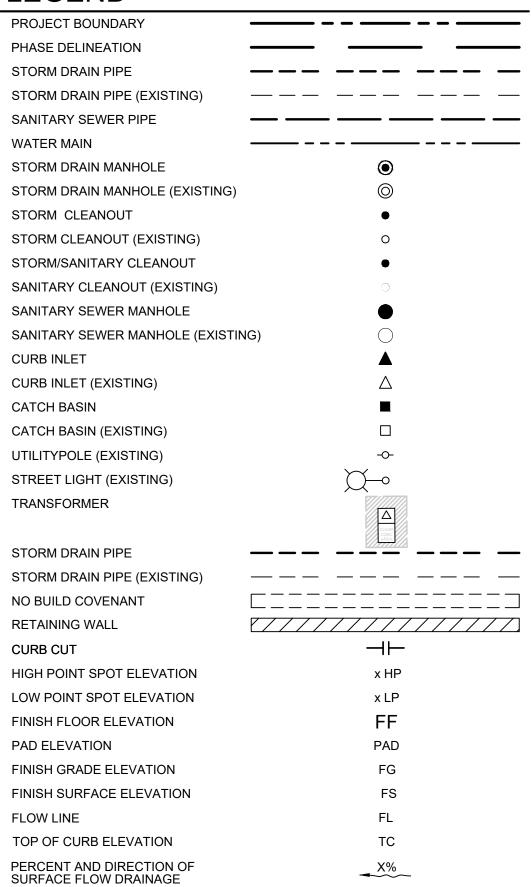


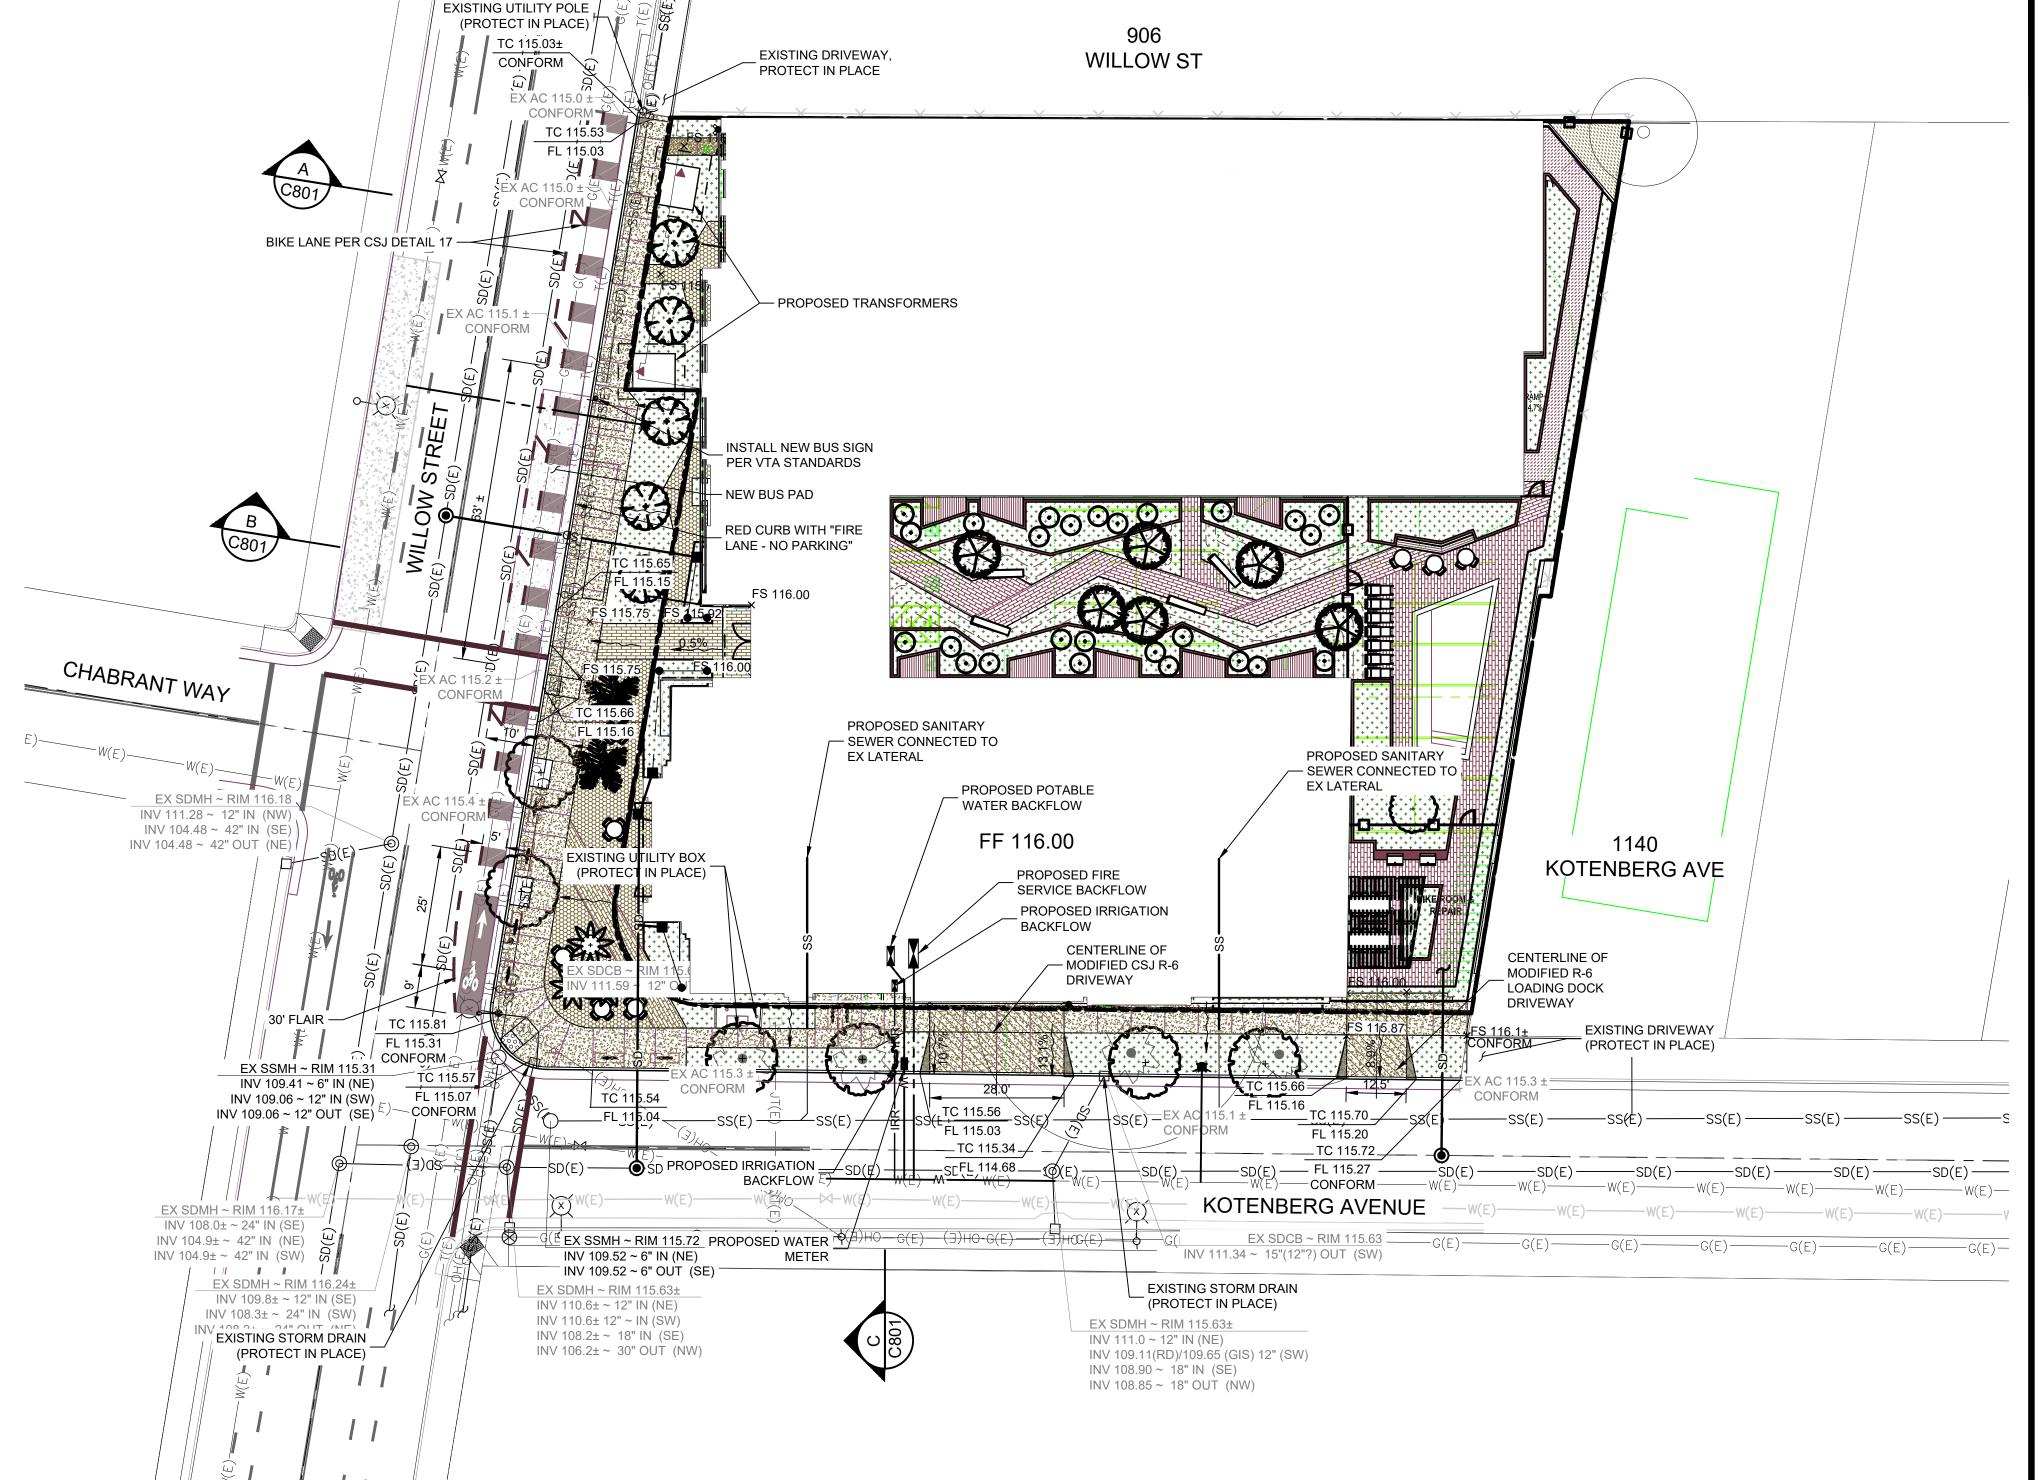
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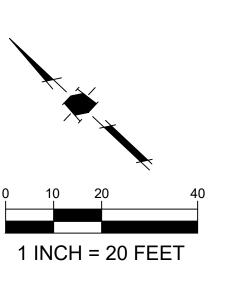
EXISTING CONDITIONS & DEMOLITION PLAN

LEGEND

OVERLAND RELEASE PATH









Project:
940 WILLOW ST,
SAN JOSE, CA
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PRELIMINARY REVIEW

evision

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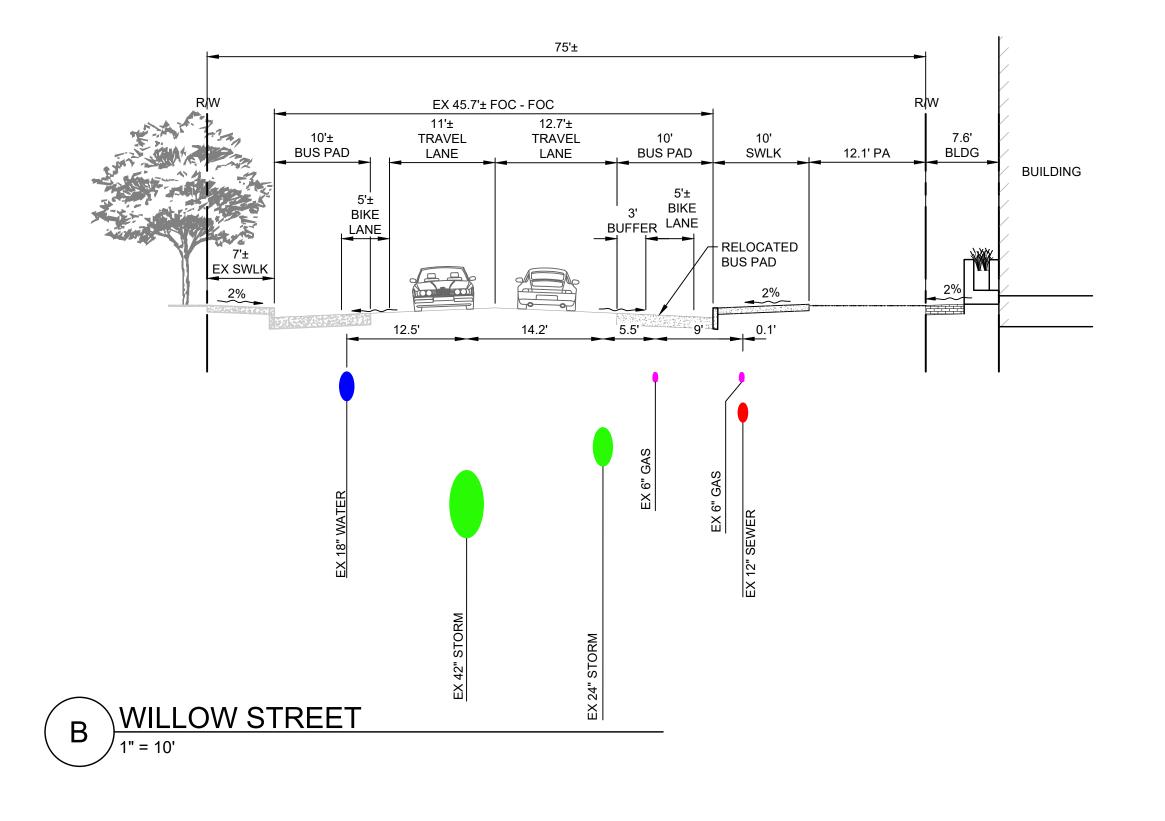
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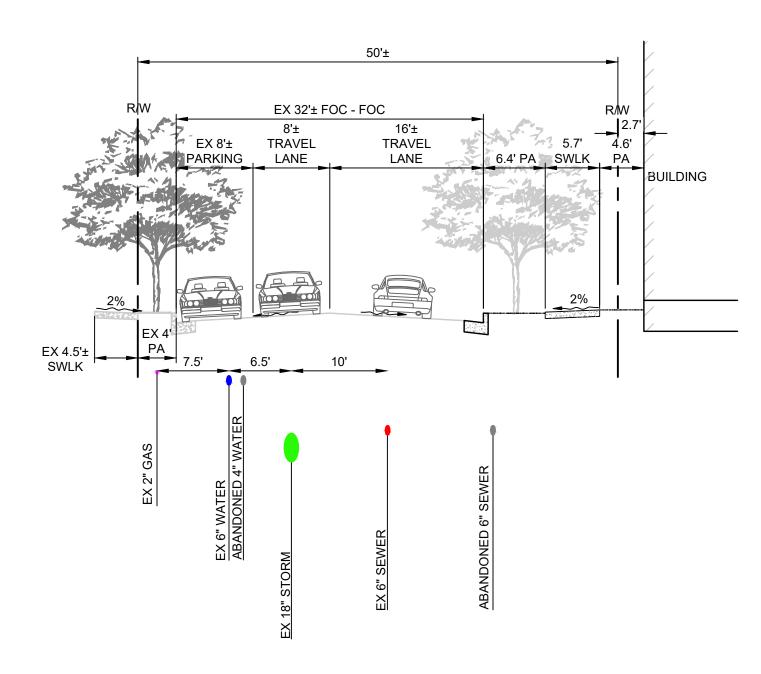
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Approved	MD
Checked	JC
Drawn	NT
Job Number	6666.0°
Issue Date	12/1/2023

GRADING & UTILITY PLAN

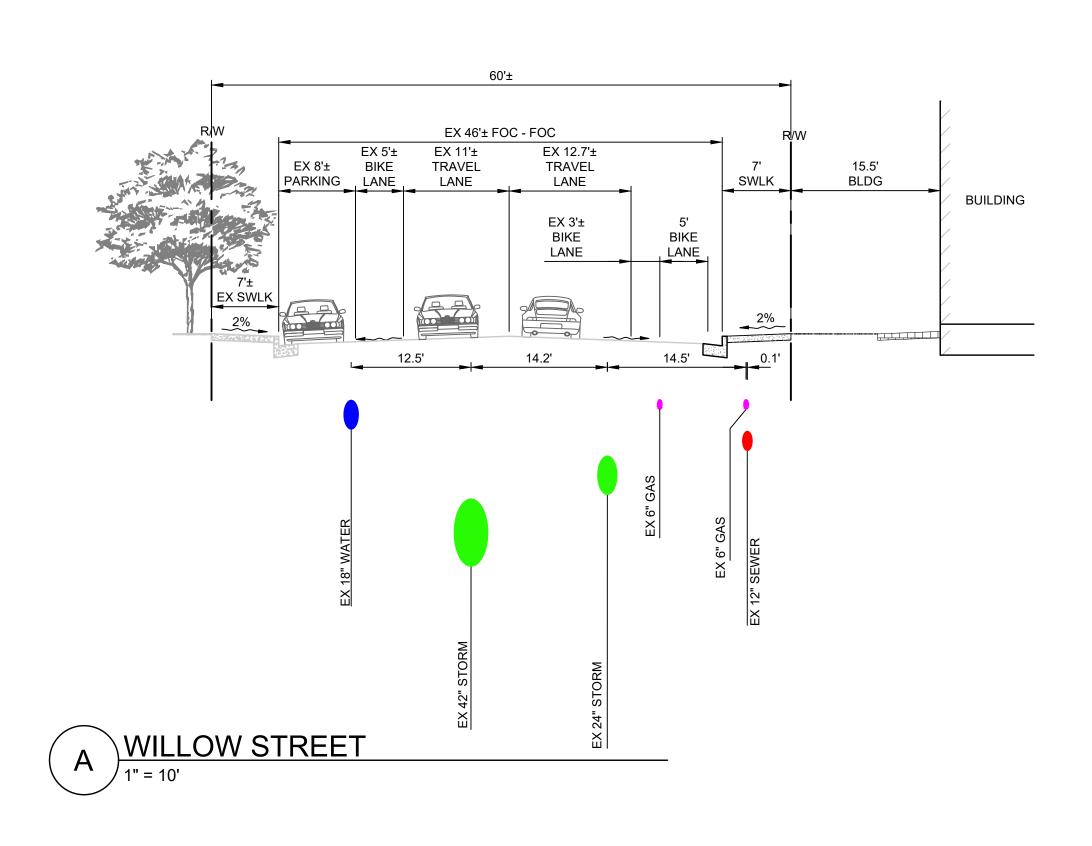
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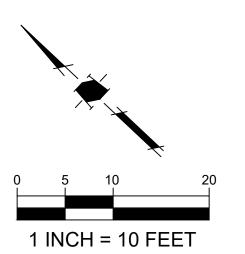
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C KOTENBERG AVENUE







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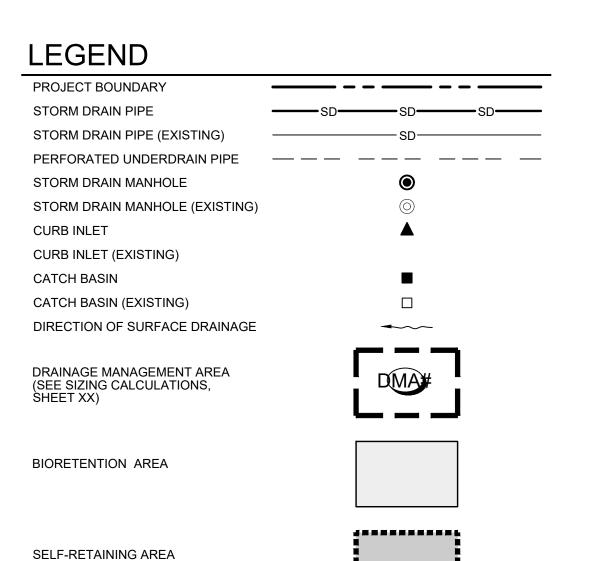
PRELIMINARY REVIEW



Sheet Information


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Scale	AS SHOWN
Approved	MD
Checked	JC
Drawn	NT
Job Number	6666.01
Issue Date	12/1/2023


CROSS-SECTIONS





NOTES:

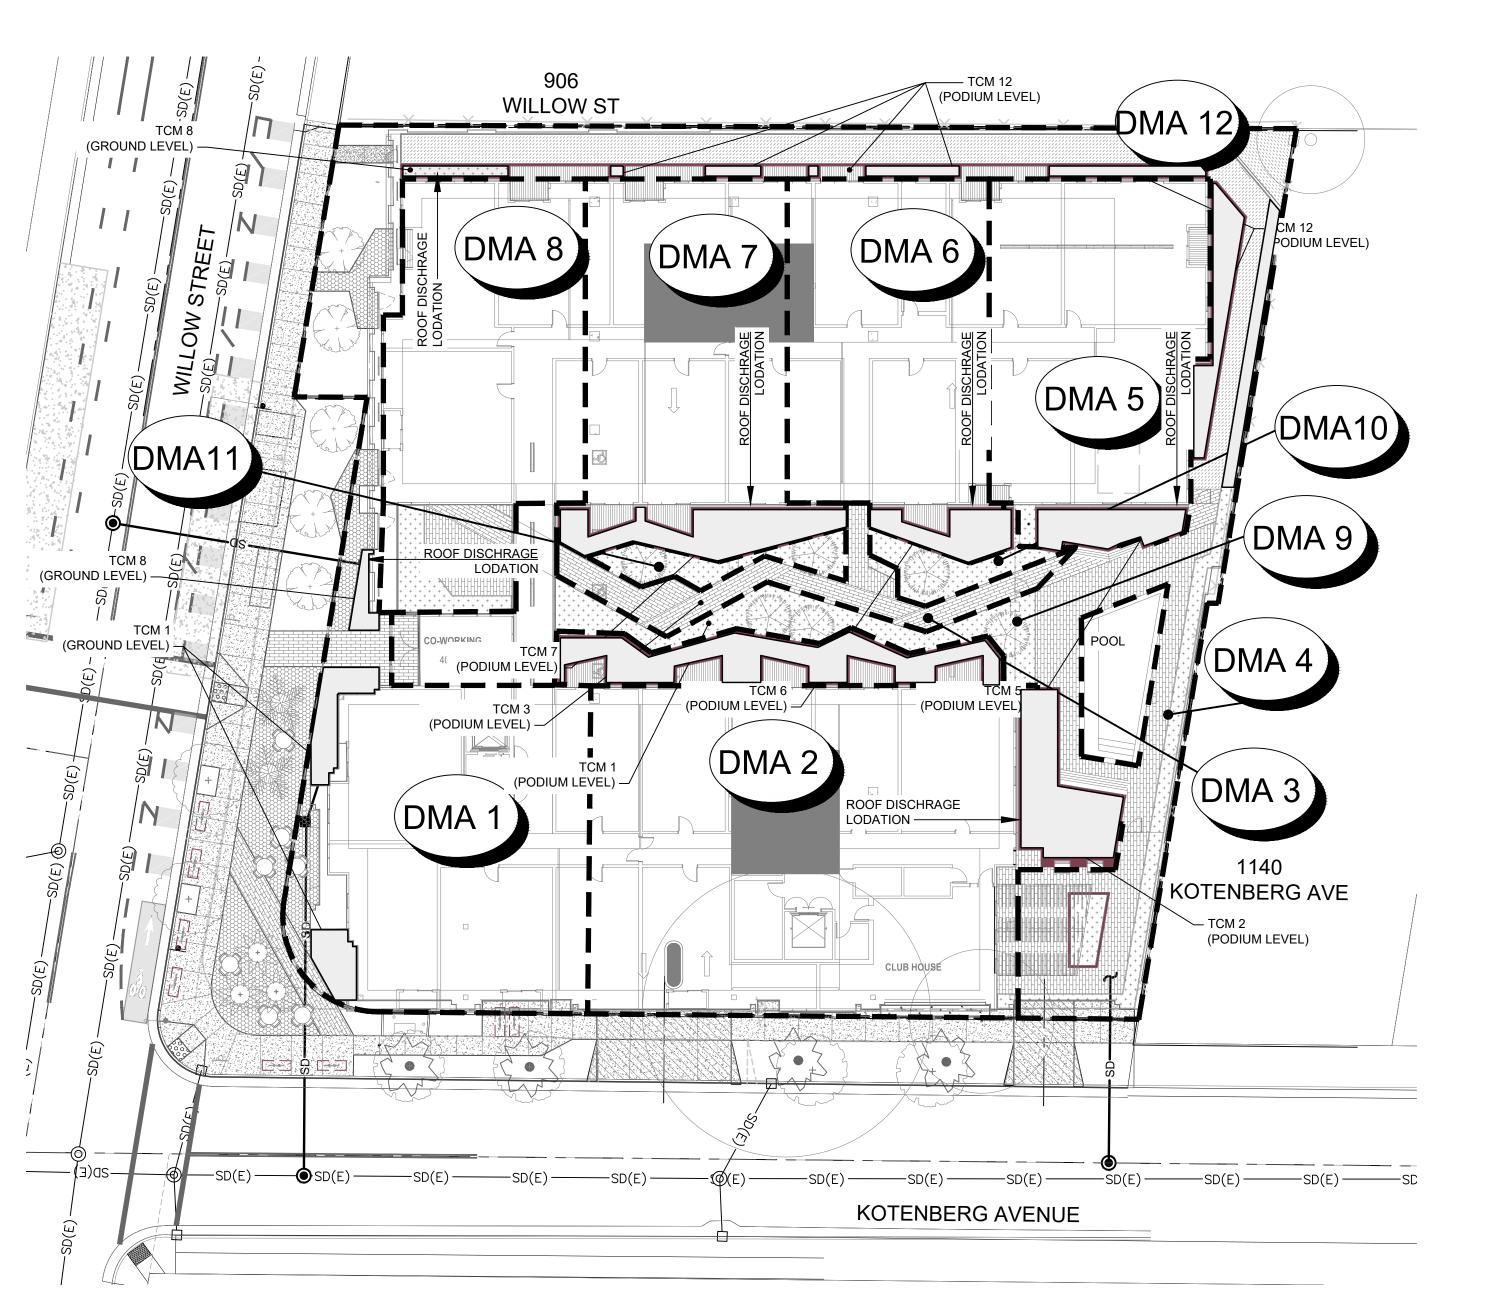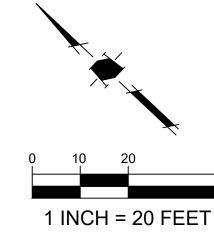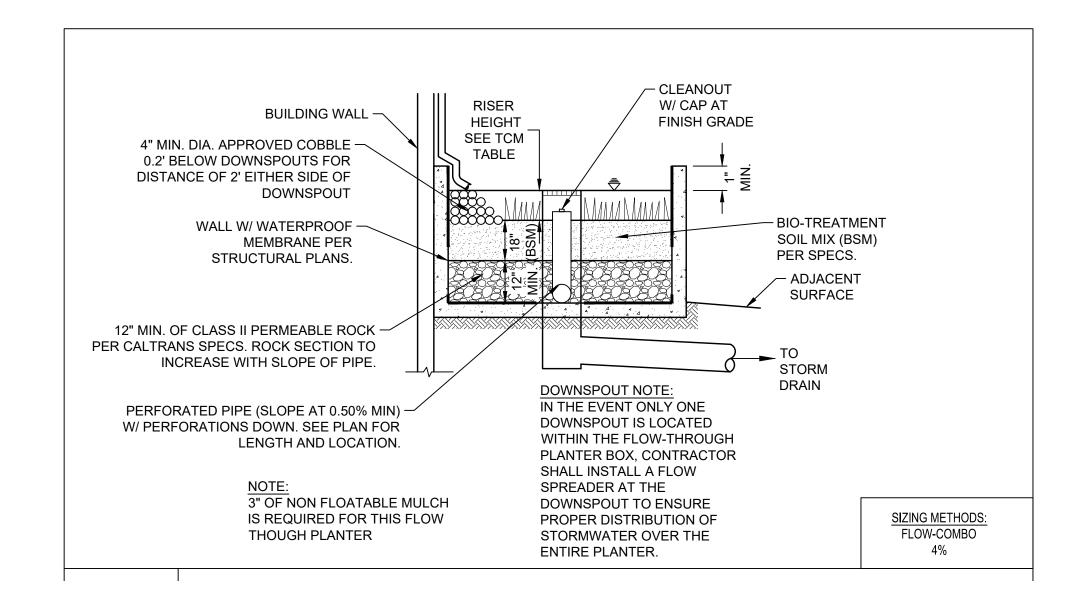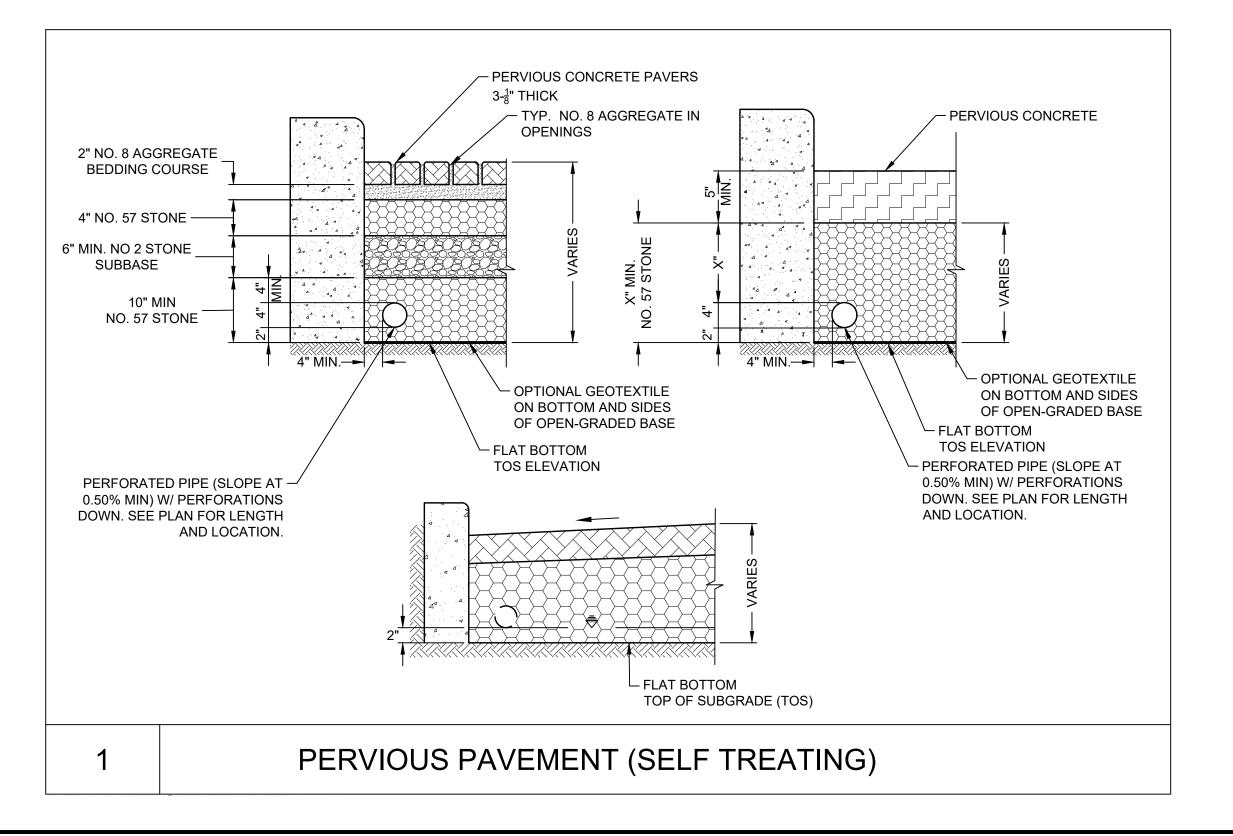- 1. PROJECT WILL NOT LOCATE OVERFLOW STRUCTURES DIRECTLY IN LINE WITH OR NEXT TO STORMWATER INLET STRUCTURES INTO FLOW-THROUGH PLANTERS
- 2. THE FINAL STORMWATER CONTROL PLAN MUST INCLUDE ACCESS AND SAFETY DESIGNS AND FEATURES FOR OPERATIONS, MAINTENANCE, AND CITY INSPECTION WHEN APPROACHING, ENTERING, AND WITHIN THE FLOW-THROUGH PLANTER BOXES.









PROJECT SITE INFORMATION:

1. SOILS TYPE: SILTY CLAY LOAM

2. GROUND WATER DEPTH: 7 FT ±

3. NAME OF RECEIVING BODY: GUADALUPE

4. FLOOD ZONE: ZONE D

5. FLOOD ELEVATION (IF APPLICABLE): N/A

SOURCE CONTROL MEASURES:

- CONNECT THE FOLLOWING FEATURES TO SANITARY SEWER: a. COVERED TRASH/ RECYCLING ENCLOSURES.
 - b. FOUNTAINS.
- 2. BENEFICIAL LANDSCAPING. 3. USE OF WATER EFFICIENT IRRIGATION SYSTEMS.
- 4. MAINTENANCE (PAVEMENT SWEEPING, CATCH BASIN CLEANING, GOOD HOUSEKEEPING).
- 5. STORM DRAIN LABELING.

SITE DESIGN MEASURES:

- 1. CLUSTER STRUCTURES/PAVEMENT.
- 2. CREATE NEW PERVIOUS AREAS:
- a. LANDSCAPING b. WALKWAYS AND PATIOS.
- c. PARKING STALLS.
- B. DIRECT RUNOFF FROM ROOFS, SIDEWALKS, PATIOS TO
- LANDSCAPED AREAS.
- 4. PLANT TREES ADJACENT TO OTHER IMPERVIOUS AREAS.



Project:

940 WILLOW ST, SAN JOSE, CA Mixed Use Proposal

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PRELIMINARY REVIEW

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Sheet Information

12/1/2023 AS SHOWN Sheet Title

Not for Construction

CONCEPTUAL STORMWATER PLAN

									REATMENT CO	NTROL MEASURE	SUMMARY TA	BLE								
												Bioretention		Self Retaini	ing / Treating		Media	Filter		
DMA#	TCM#	Location1	Treatment Type2	LID or Non-LID	Sizing Method	Drainage Area (s.f.)	Impervious Area4 (s.f.)	Pervious Area (Permeable Pavement) (s.f.)	Pervious Area (Other) (s.f.)	% Onsite Area Treated by LID or Non-LID TCM	Bioretention Area Required (s.f.)	Bioretention Area Provided (s.f.)	Overflow Riser Height (in)	Storage Depth Required (ft)	Storage Depth Provided (ft)	# of Cartridges Required	# of Cartridges Provided	Media Type	Cartridge Height (inches) Treatment Credit (s.	(
1	1	Onsite	Flow-Through planter (concrete lined) w/ underdrain	LID	2C. Flow: 4% Method **	6,393	6,393			15.83%	256	834	6"							ROOF AND GROUND LEVEL HARDSCAP
2	2	Onsite	Flow-Through planter (concrete lined) w/ underdrain	LID	2C. Flow: 4% Method **	6,645	6,645			16.45%	266	242	6"							ROOF
3	3	Onsite	Self-treating areas (landscaped)	LID	N/A	735	735			1.82%	-	-								PODIUM LEVEL HARDSCAP
-	-	-	Swimming Pool	-	-	441	-	-	-	-	-	-	-							SWIMMING POOL
4	4	Onsite	Flow-Through planter (concrete lined) w/ underdrain	LID	2C. Flow: 4% Method **	2,272	1,974		298	5.63%	79	820	6"							PODIUM LEVEL HARDSCAPE
5	5	Onsite	Flow-Through planter (concrete lined) w/ underdrain	LID	2C. Flow: 4% Method **	3,257	3,257			8.06%	130	213	6"							ROOF
6	6	Onsite	Flow-Through planter (concrete lined) w/ underdrain	LID	2C. Flow: 4% Method **	3,142	3,142			7.78%	126	192	6"							ROOF
7	7	Onsite	Flow-Through planter (concrete lined) w/ underdrain	LID	2C. Flow: 4% Method **	3,423	3,423			8.48%	137	386	6"							ROOF
8	8	Onsite	Flow-Through planter (concrete lined) w/ underdrain	LID	2C. Flow: 4% Method **	3,288	3,081		207	8.14%	123	99	6"							ROOF
9	9	Onsite	Self-treating areas (landscaped)	LID	N/A	724			724	1.79%	-	-								PODIUM LANDSCAPI G
10	10	Onsite	Self-treating areas (landscaped)	LID	N/A	296			296	0.73%	-	-								PODIUM LANDSCAPI G
11	11	Onsite	Self-treating areas (landscaped)	LID	N/A	301			301	0.75%	-	-								PODIUM LANDSCAPI G
12	12	Onsite	Flow-Through planter (concrete lined) w/ underdrain	LID	2C. Flow: 4% Method *		3,545		145	9.14%	148	503								PERVIOUS PATIOS ANI LASDSCAPI G
	13	Onsite	Maintenance	LID	N/A	6,221	0		6,221	15.40%	-	-	1	10"	10"			<u> </u>	1	

Footnotes

- 1 Per the Municipal Regional Stormwater Permit, sidewalks and other parts of the right-of-way should be included in the new and/or replaced impervious surface calculation and treated as required
- 2 "Lined" refers to an impermeable liner placed on the bottom of a Bioretention basin or a concrete Flow-Through Planter, such that no infiltration into native soil occurs.
- 3 Sizing for Bioretention Area Required calculated using the 4% Method (Impervious Area x 0.04)
- 4 Gravel is considered as an impervious surface unless it is part of an infiltration trench.
- 5 Treatment type of Self-Treating or Self-Retaining should only be used with landscape based treatment. If previous pavement is proposed for Self-Treating or Retaining, use the Pervious Pavement selection.

32,195

8,192

100.00%

	TABLE 1 ROUTINE MAINTENANCE ACTIVITIES FOR FLOW-THROUGH PLANTERS	5
NO.	MAINTENANCE TASK	FREQUENCY OF TASK
1	INSPECT THE PLANTER SURFACE AREA, INLETS AND OUTLETS FOR OBSTRUCTIONS AND TRASH; CLEAR ANY OBSTRUCTIONS AND REMOVE TRASH.	QUARTERLY
2	INSPECT PLANTER FOR STANDING WATER. IF STANDING WATER DOES NOT DRAIN WITHIN 2-3 DAYS, THE SURFACE BIOTREATMENT SOIL SHOULD BE TILLED OR REPLACED WITH THE APPROVED SOIL MIX AND REPLANTED. USE THE CLEANOUT RISER TO CLEAR ANY UNDERDRAINS OF OBSTRUCTIONS OR CLOGGING MATERIAL.	QUARTERLY
3	CHECK FOR ERODED OR SETTLED BIOTREATMENT SOIL MEDIA. LEVEL SOIL WITH RAKE AND REMOVE/REPLANT VEGETATION AS NECESSARY.	QUARTERLY
4	MAINTAIN THE VEGETATION AND IRRIGATION SYSTEM. PRUNE AND WEED TO KEEP FLOW-THROUGH PLANTER NEAT AND ORDERLY IN APPEARANCE.	QUARTERLY
5	EVALUATE HEALTH AND DENSITY OF VEGETATION. REMOVE AND REPLACE ALL DEAD AND DISEASED VEGETATION. REMOVE EXCESSIVE GROWTH OF PLANTS THAT ARE TOO CLOSE TOGETHER.	ANNUALLY, BEFORE THE RAINY SEASON BEGINS
6	USE COMPOST AND OTHER NATURAL SOIL AMENDMENTS AND FERTILIZERS INSTEAD OF SYNTHETIC FERTILIZERS, ESPECIALLY IF THE SYSTEM USES AN UNDERDRAIN.	ANNUALLY, BEFORE THE RAINY SEASON BEGINS
7	INSPECT THE OVERFLOW PIPE TO MAKE SURE THAT IT CAN SAFELY CONVEY EXCESS FLOWS TO A STORM DRAIN. REPAIR OR REPLACE ANY DAMAGED OR DISCONNECTED PIPING. USE THE CLEANOUT RISER TO CLEAR UNDERDRAINS OF OBSTRUCTIONS OR CLOGGING MATERIAL.	ANNUALLY, BEFORE THE RAINY SEASON BEGINS
8	INSPECT THE ENERGY DISSIPATOR AT THE INLET TO ENSURE IT IS FUNCTIONING ADEQUATELY, AND THAT THERE IS NO SCOUR OF THE SURFACE MULCH. REMOVE ANY ACCUMULATION OF SEDIMENT.	ANNUALLY, BEFORE THE RAINY SEASON BEGINS
9	INSPECT AND, IF NEEDED, REPLACE WOOD MULCH. IT IS RECOMMENDED THAT 2" TO 3" OF COMPOSTED ARBOR MULCH BE APPLIED ONCE A YEAR.	ANNUALLY, BEFORE THE RAINY SEASON BEGINS
10	INSPECT SYSTEM FOR EROSION OF BIOTREATMENT SOIL MEDIA, LOSS OF MULCH, STANDING WATER, CLOGGED OVERFLOWS, WEEDS, TRASH AND DEAD PLANTS. IF USING ROCK MULCH, CHECK FOR 3" OF COVERAGE.	ANNUALLY AT THE END OF THE RAINY SEASON AND/OR AFTER LARGE STORM EVENTS,
11	INSPECT SYSTEM FOR STRUCTURAL INTEGRITY OF WALLS, FLOW SPREADERS, ENERGY DISSIPATORS, CURB CUTS, OUTLETS AND FLOW SPLITTERS.	ANNUALLY AT THE END OF THE RAINY SEASON AND/OR AFTER LARGE STORM EVENTS,

	OPERATION AND MAINTENANCE INFORMATION:	
	OPERTY INFORMATION: A. PROPERTY ADDRESS: 940 WILLOW ST	
	SAN JOSE, CA 95125	
I.E	B. PROPERTY OWNER: X X	
	A. CONTACT: X	
II.	.B. PHONE NUMBER OF CONTACT:	
II.	.C. EMAIL:	
II.	.D. ADDRESS: X	

3,289

STANDARD STORMWATER CONTROL NOTES:

- STANDING WATER SHALL NOT REMAIN IN THE TREATMENT MEASURES FOR MORE THAN FIVE DAYS, TO PREVENT MOSQUITO GENERATION. SHOULD ANY MOSQUITO ISSUES ARISE, CONTACT THE SANTA CLARA VALLEY VECTOR CONTROL DISTRICT (DISTRICT). MOSQUITO LARVICIDES SHALL BE APPLIED ONLY WHEN ABSOLUTELY NECESSARY, AS INDICATED BY THE DISTRICT, AND THEN ONLY BY A LICENSED PROFESSIONAL OR CONTRACTOR. CONTACT INFORMATION FOR THE DISTRICT IS PROVIDED BELOW.
- DO NOT USE PESTICIDES OR OTHER CHEMICAL APPLICATIONS TO TREAT DISEASED PLANTS, CONTROL WEEDS OR REMOVED UNWANTED GROWTH. EMPLOY NON-CHEMICAL CONTROLS (BIOLOGICAL, PHYSICAL AND CULTURAL CONTROLS) TO TREAT A PEST PROBLEM. PRUNE PLANTS PROPERLY AND AT THE APPROPRIATE TIME OF YEAR. PROVIDE ADEQUATE IRRIGATION FOR LANDSCAPE PLANTS. DO NOT OVER WATER.

2.a Enter the Project Phase Number (1, 2, 3,	etc. or N/A if No	ot Applicable): ${ m N}$	T/A		
2.b Total area of site:	0.80	acres			
2.c Total area of site that will be disturbed $^{1}\colon$	0.80	acres			
COMPARISON OF IMPERVIOUS AND PERV	IOUS AREAS A	T PROJECT SITE:	:	:	
2.d IMPERVIOUS AREAS - IA ²	Pre-Project Existing IA sq. ft.	Existing IA Retained As-Is ³ sq. ft.	Existing IA Replaced with IA ⁴ sq. ft.	New IA Created ⁴ sq. ft.	Total Post Project IA sq. ft.
Site Totals	,		,		, 54
Total onsite IA	d.1 29,407	d.2	d.3 28,506	d.4	d.5 (d.2+d.3+d.4) 28,506
Total off-site IA ²	d.6 4,759	d.7	d.8	d.9 359	d.10 (d.7+d8+d.9) 5,118
Total project IA	d.11 (d.1+d.6) 34,166	d.12 (d.2 +d.7)	d.13 (d.3 +d.8) 28,506	d.14 (d.4 +d.9) 359	d.15 (d.5 +d.10) 33,624
Total New and Replaced IA			d.16 (d.13+d.14) 33,624		
Percent Replacement of onsite IA in Rede	velopment Projec	cts (d.3÷d.1) x 100	:		^d 100 %
2.e PERVIOUS AREAS - PA ⁵	Pre-Project Existing PA sq. ft.				Total Post Project PA sq. ft.
Total on-site PA	e.1 4,100				e.2 5,260
Total off-site PA	e.3 1,462				e ₁ ,503
Total PA ⁵	e.5 (e.1+e.3) 5,562				e.6 (e.2+e.4) 6,763
2.f Total Area (IA + PA)	f.1 (d.11 + e.5) 40,387	_			f.2 (d.15 + e.6) 40,387



Project:
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SAN JOSE, CA
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PRELIMINARY REVIEW

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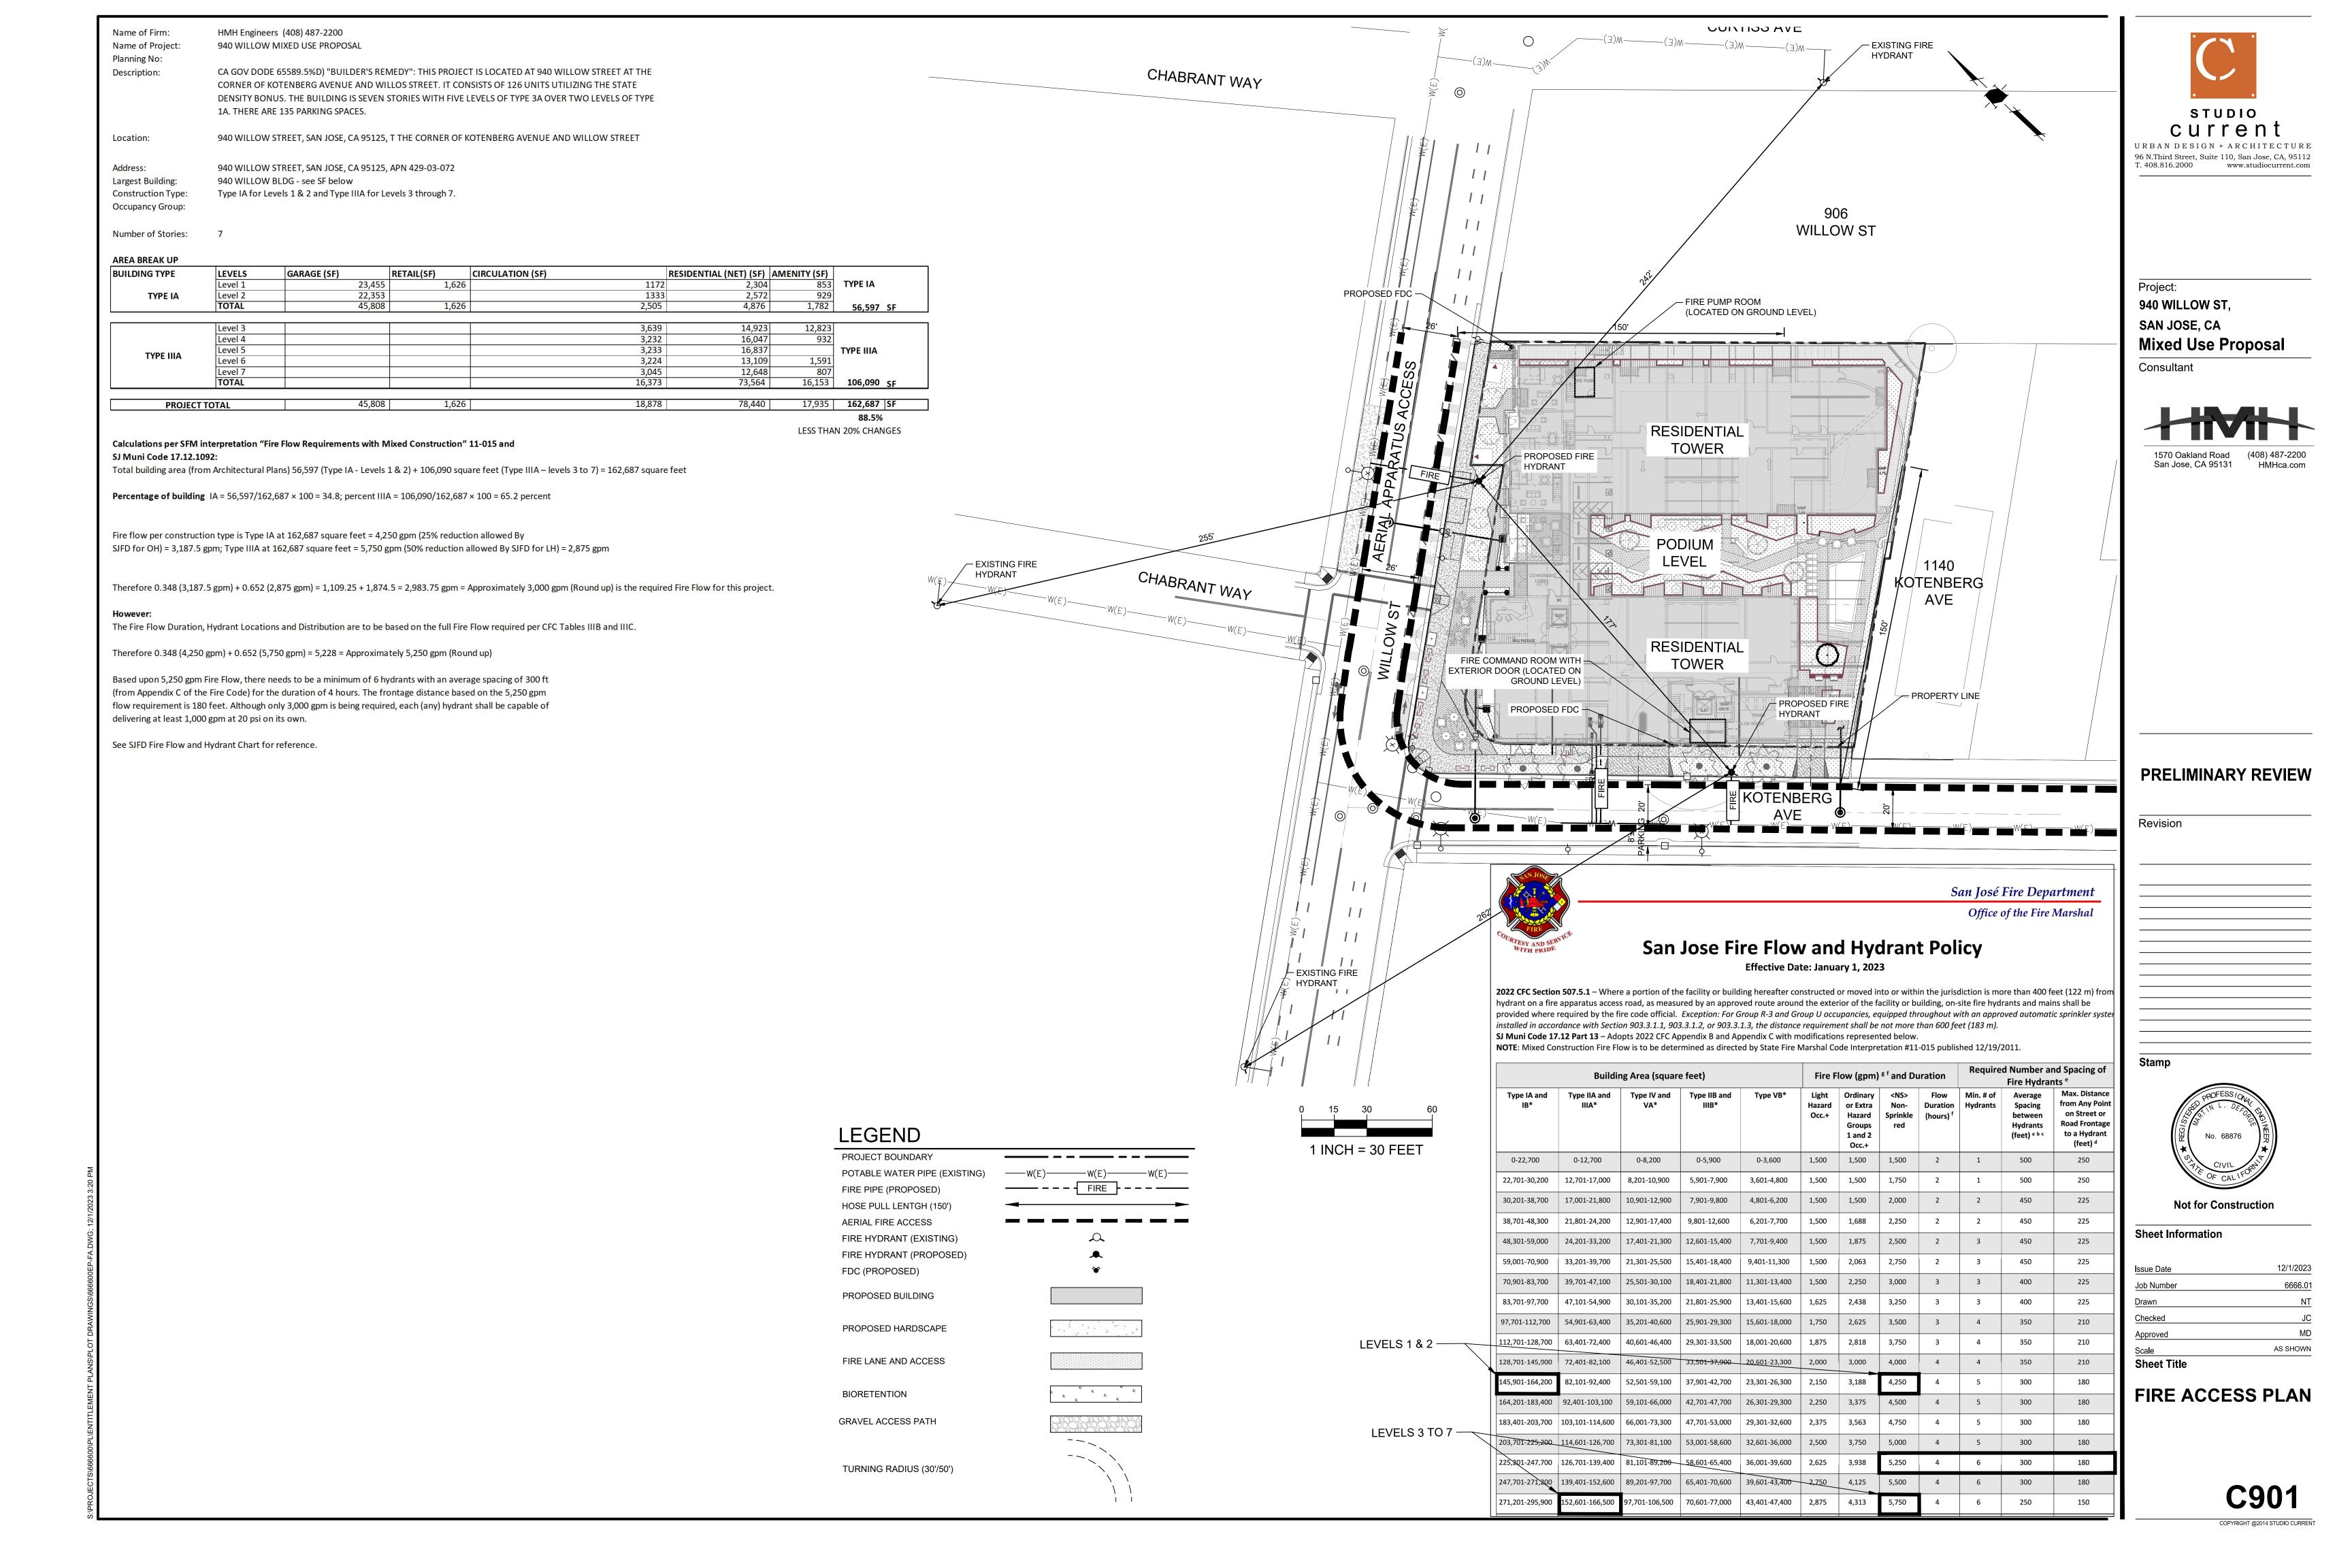



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Sheet Information

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Issue Date	12/1/2023
Job Number	6666.01
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Checked	JC
Approved	MD
Scale	AS SHOWN
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CONCEPTUAL
STORMWATER
PLAN DETAILS





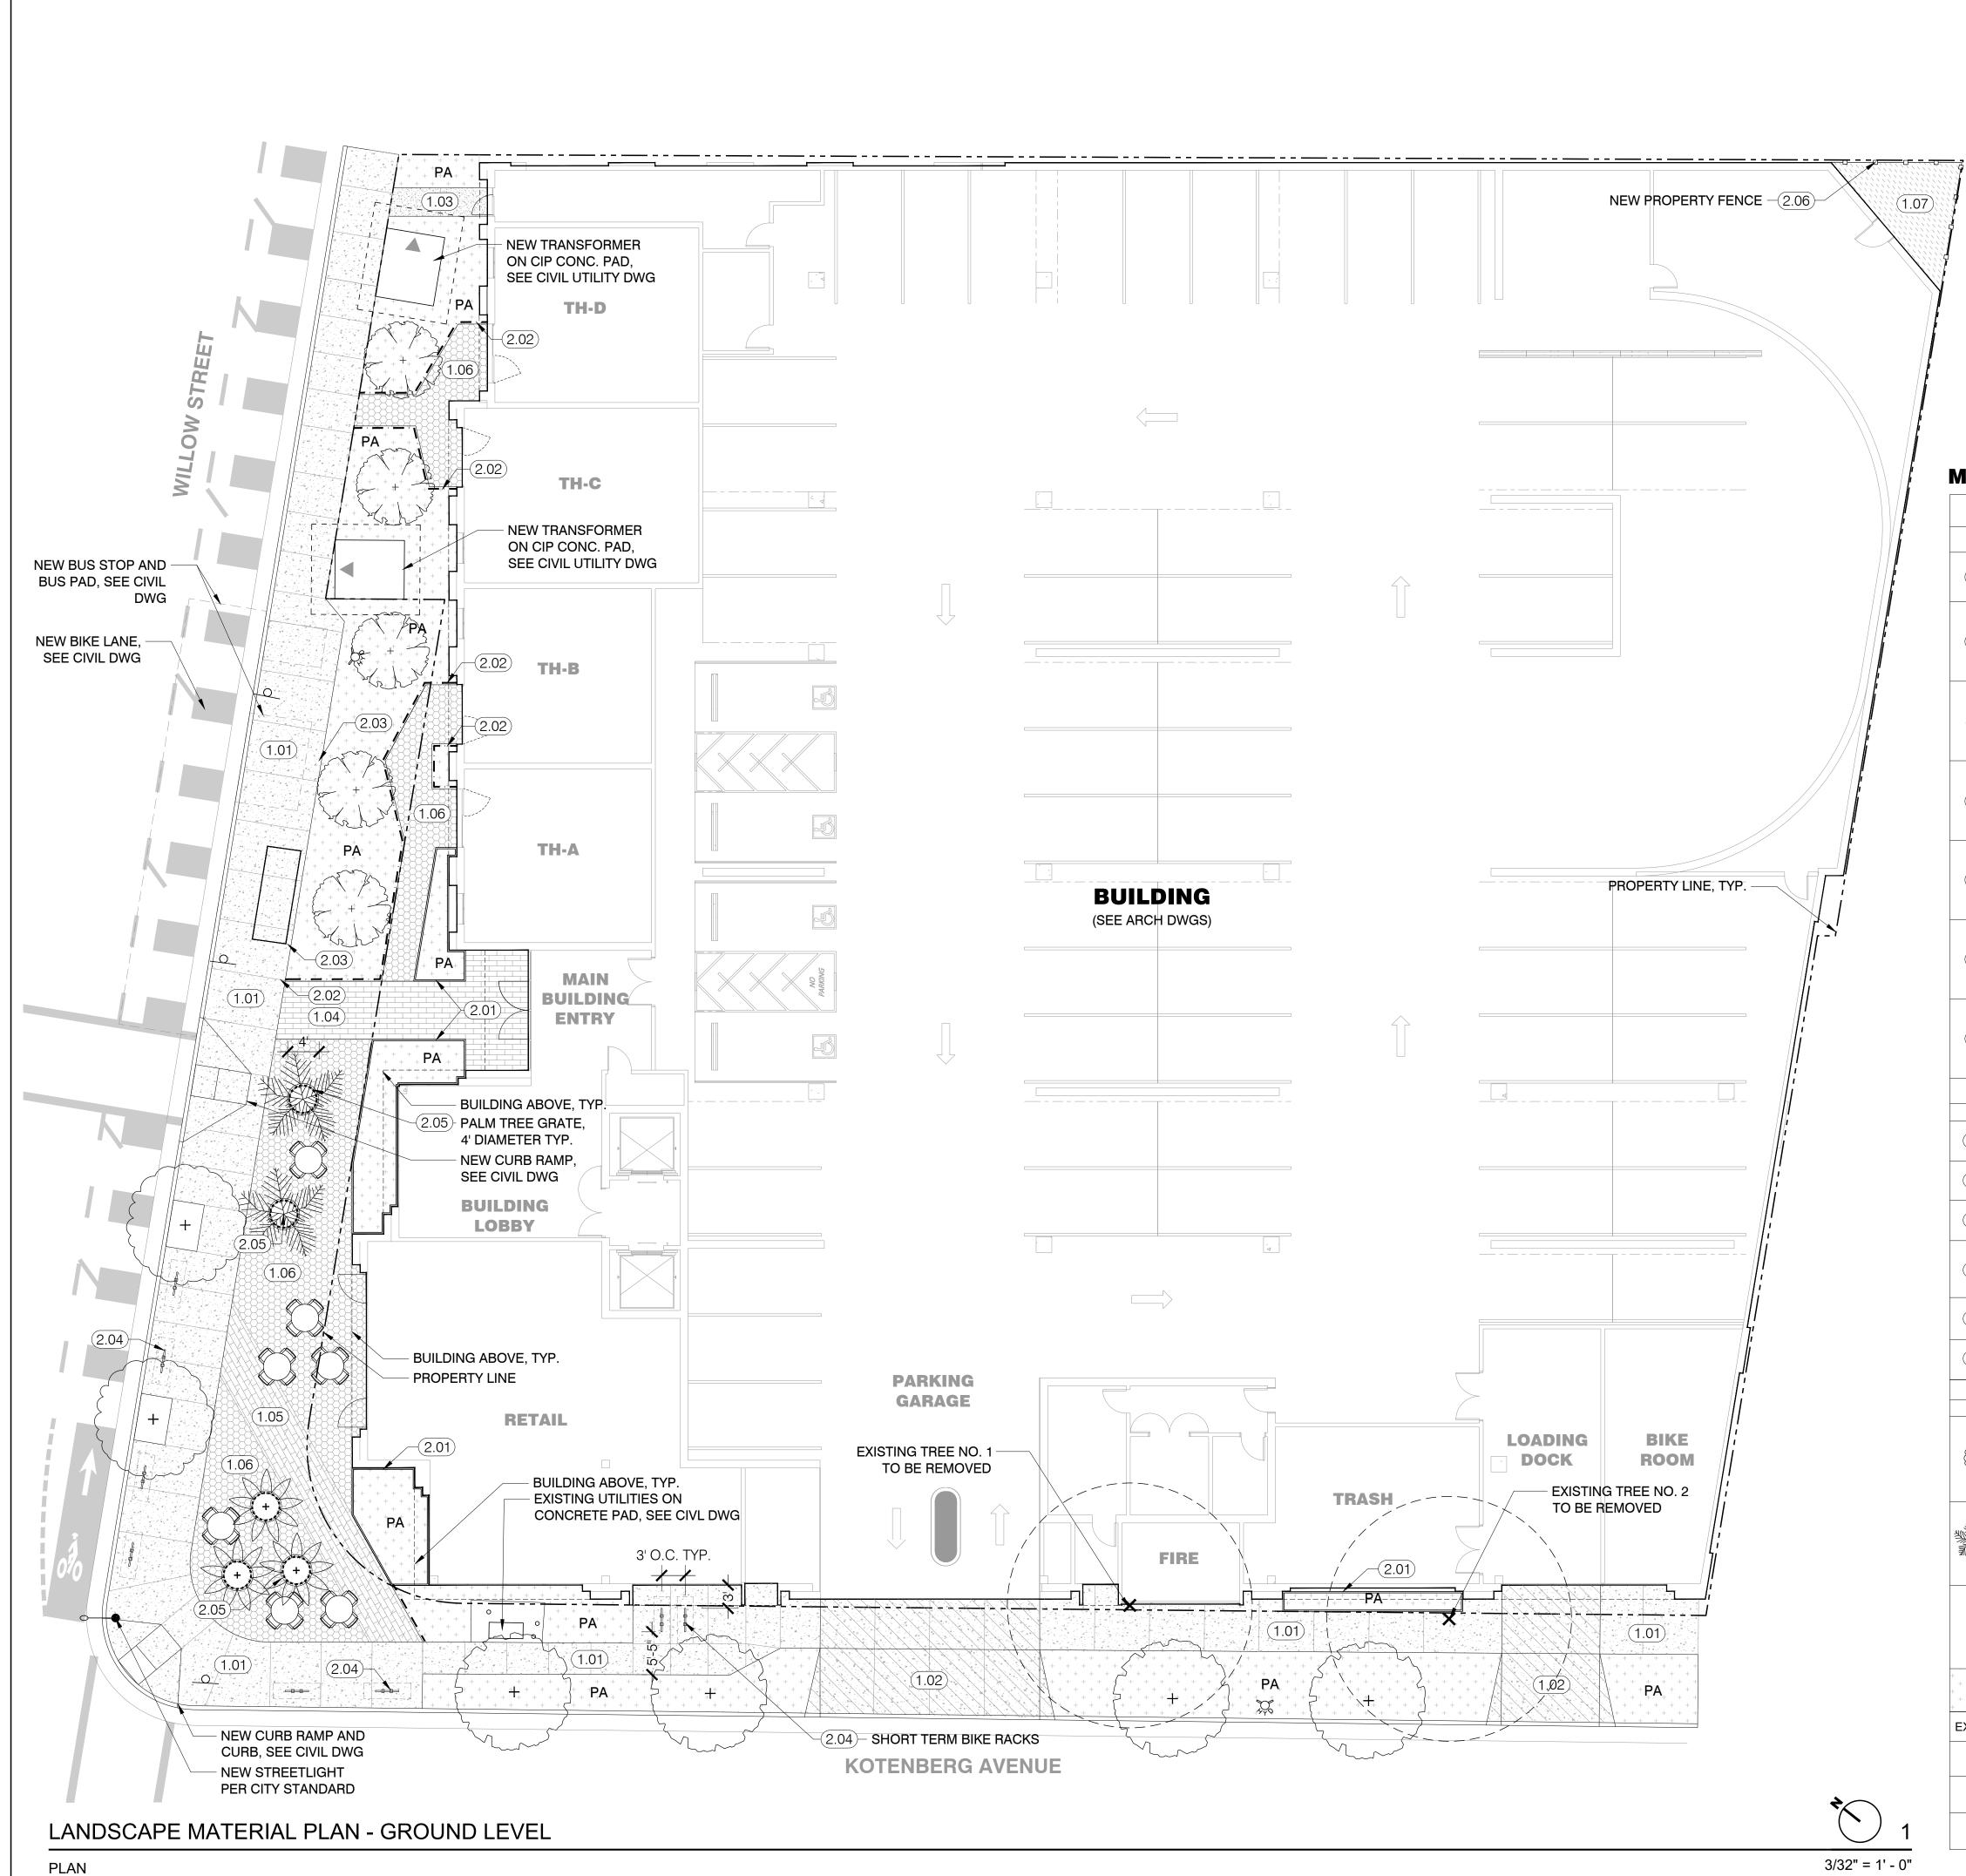- 1. For Building Details, See Arch Dwgs.
- 2. For Utilities and Street Improvement Details, See Civil Dwgs.

INFILTRATION

- 3. For Planting Information, See Landscape Planting Plans
- 7. "I agree to comply with, or cause anyone who works on the landscape design plan to comply with, the requirements of Chapter 15.11 of Title 15 of the San Jose Municipal Code and to submit a complete landscape design plan that complies with Chapter 15.11 of Title 15 of the San Jose Municipal Code."

LID MEASURE CALCULATION (CITYWIDE DESIGN GUIDELINES SECTION 2.3.8 STANDARD 8) TOTAL AREA: 3778 SF (MEASURED FROM BACK OF SIDEWALK TO BUILDING FACE) SQUARE FOOTAGE PERCENTAGE OF TOTAL AREA PERMEABLE 1921 SF 50% PAVING ON GRADE PLANTING TO 1190 SF 31% ALLOW FOR

MATERIALS LEGEND - GROUND LEVEL

NO.	SYMB.	ITEM	DESCRIPTION	DETA
(1.01)		CITY SIDEWALK	Concrete Sidewalk Per Streetscape Standard Details, See Civil Dwgs.	
1.02		CONCRETE PAVEMENT - VEHICULAR	See Civil Dwgs.	
1.03		CONCRETE PAVEMENT - PEDESTRIAN	CIP Reinforced Concrete Per Geotech Recommendation. Integral Color with Sand Float Finish. See Arch Dwgs for Pavement Adjacent to Building.	
1.04		LINEAR CONCRETE PAVER- ON GRADE	Precast Concrete Paver from Stepstone, Inc., Sand Set over Compacted Aggregate Base Per Geotech Recommendation.	
1.05		LINEAR PERMBEABLE CONCRETE PAVER- ON GRADE	Precast Concrete Paver from Stepstone, Inc., With Permeable Setting Bed and Aggregate Base Per Geotech Recommendation.	
1.06		PERMEABLE CONCRETE PAVER - ON GRADE	Precast Concrete Paver from Stepstone, Inc., With Permeable Setting Bed and Aggregate Base Per Geotech Recommendation.	
(1.07)		GRAVEL PAVEMENT	2" Decorative Gravel over Filter Fabric	

NO. SYMB. DESCRIPTION DETAIL METAL PLANTER WALL Custom Aluminum Planter from Planterworx $\frac{3}{16}$ " x 4" Duraedge or Similar, Black Powdercoat LANDSCAPE EDGING Finish. Spot Weld at Corners, Typ. Bus Shelter Per City Standard **BUS SHELTER** Short Term Bike Parking, Surface Mounted Bike Rack Per City Specifications. Bicycle 2.04 **BIKE RACK** ----Space is 2' x 6' and are set 3' O.C. Where Installed In Sequence
4' Dia. Circular Tree Grate by Iron Age. Tree wells To Be At Least Four Feet Larger Than TREE GRATE Tree Trunk Diameter At Maturity SITE FENCE 6' H Perimeter Wood Fence

3.00	PLANTING			
SYMBOL		ITEM	DESCRIPTION	DETAIL
+	+	PROPOSED STREET TREE (MEDIUM TREE SIZE)	25' O.C. Spacing Max and 12' Minimum Distance From Building Face. For Layout, See Planting Plan, Species Per Recommendation of City Arborist. 1400 Cubic Feet of Non-compacted Soil to Be Provided In Continuous Planting Trenches.	
		PROPOSED SITE TREE	20' O.C. Spacing Max and 5' Minimum Distance From Building Face.For Layout, See Planting Plan. Provide Non-compacted Soil to Meet Criteria Outlined in Citywide Design Guidelines Section 2.3.8 S3.	
	×	EXISTING SITE TREES	Species And Replacement Strategy To Be Determined Based on Pending Arborist Report	
+ + + +	PA+ + + + +	PLANTING AREA	See Planting Plan	

EXISTING TREES & MITIGATION

PLANTING AREA

PA

NO.	SPECIES	NATIVE / NON-NATIVE	SIZE	STATUS	REPLACEMENT
1	Pinus TBD	NON-NATIVE	24" DIA	TO BE REMOVED	TBD
2	Pinus TBD	NON-NATIVE	36" DIA	TO BE REMOVED	TBD

and Planting Details



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Checked	MA
Drawn	AS
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LANDSCAPE MATERIAL PLAN - GROUND LEVEL

6' FIRE DEPARTMENT ACCESS (1.03) 1.02 PA 1.02 + PA+ + 1.02 2.02 **BUILDING** (SEE ARCH DWGS) 1.02 2.09 2.02 (2.02) + PA+ (2.02) **CO-WORKING** 2.01 **BUILDING** (SEE ARCH DWGS) **CLUB HOUSE** 2.08

NOTES:

- 1. For Building Details, See Arch Dwgs.
- 2. For Building Drainage, See Civil Dwgs
- 3. For Planting Information, See Landscape Planting Plans
- 7. "I agree to comply with, or cause anyone who works on the landscape design plan to comply with, the requirements of Chapter 15.11 of Title 15 of the San Jose Municipal Code and to submit a complete landscape design plan that complies with Chapter 15.11 of Title 15 of the San Jose Municipal Code."



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MATERIALS LEGEND - LEVEL 3

— PARAPET RAILING, SEE ARCH DWG

NO.	SYMB.	ITEM	DESCRIPTION	DETAIL
(1.01)		LINEAR CONCRETE PAVER- ON STRUCTURE	Precast Concrete Paver from Stepstone, Inc. over Clean Washed Drain Rock, Filter Fabric, and Drainage Board on Waterproofed Roof Deck.	
(1.02)		WOOD DECK - ON STRUCTURE	1x6 lpe Wood Decking	
1.03		GRAVEL PAVING - ON STRUCTURE	2" Decorative Gravel over Filter Fabric, Clean Washed Drain Rock, and Drainage board.	
2.00	WALLS, GATE	ES, FENCES,MISC		
NO.	SYMB.	ITEM	DESCRIPTION	DETAIL
(2.01)		SWIMMING POOL	Swimming Pool with 'Cabo' Shelf and Precast Concrete Coping. 42" Water Depth	
2.02		CIP PLANTER WALL	CIP Boardform Concrete Wall, 36' Internal Depth, 30" H Above Finished Grade of Paving, Integral Color	
2.03		DUNE EDGING	¹ / ₄ " Steel Plate with Clear Sealant, Spot Weld at Corners, Attach to L-Angle Supports on Podium, 24" O.C.	
2.04)		PLANTER BENCH	Ipe Wood Bench & Back Rest Mounted to CIP Wall	
2.05		PLANTER LOUNGE	Ipe Wood Seat & Lounge, Mounted to CIP Wall	
2.06		STONE SLAB BENCH	18" Tall Bench Composed of 3 Stacked Stone Slabs over CIP Concrete Base	
2.07)		BBQ COUNTER	36" Tall CIP Concrete Counter with Built-in Gas Grill and Custom Cabinets with Powdercoated Aluminum Doors. Smooth MDF Form Finish, Integral Color, See Details.	
(2.08)		SHADE STRUCTURE	Steel Shade Structure, Hot Dipped Galvanized and Painted Black, with Ipe Louvers.	
2.09		POOL FENCE	5' High Fence and Gate with Self Closing Hinges and Keyed Entry	
2.10	+ + + + + + + + + + + + + + + + + + + +	PARAPET TROUGH PLANTER	Custom 42" H Aluminum Planter from Planterworx	
3.00	PLANTING	1751	DECODIDETION	DET
SY	′MBOL	ITEM	DESCRIPTION	DETAIL
+	The state of the s	PROPOSED TREE	See Planting Plan and Planting Details	
+ + + + + + + + + + + + + + + + + + + +	PA++++++++++++++++++++++++++++++++++++	PLANTING AREA	See Planting Plan and Planting Details	
+++	PA (+)	C.3 FLOW-THROUGH PLANTER	See Planting Plan and Planting Details	

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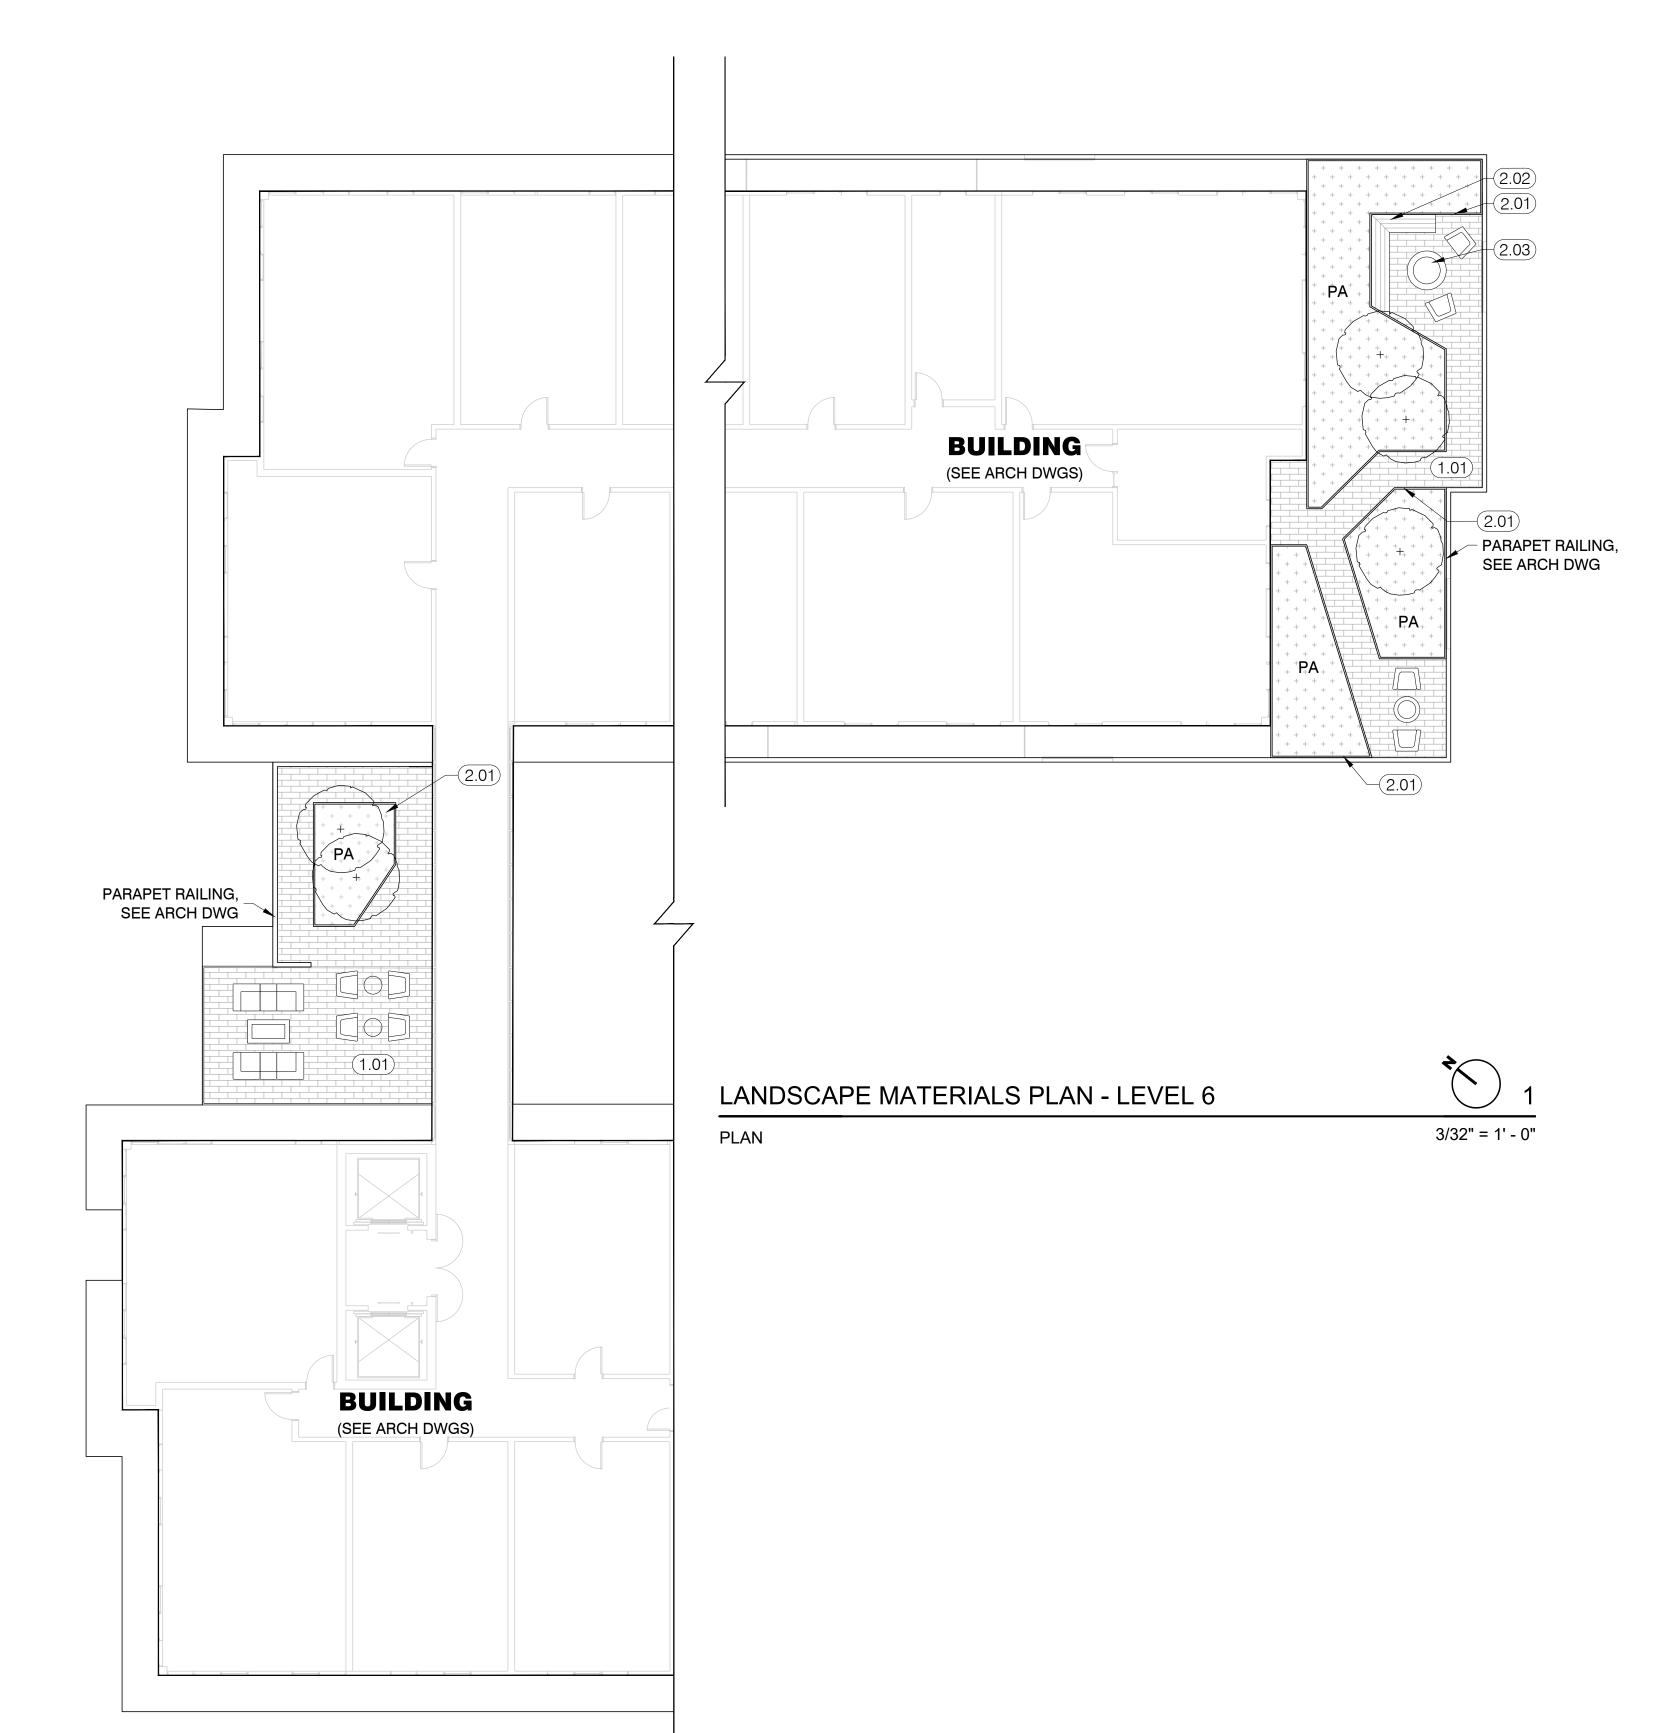


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LANDSCAPE MATERIALS PLAN - LEVEL 3

PLAN



MATERIALS LEGEND - LEVELS 6 & 7

LINEAR CONCRETE

PAVER- ON STRUCTURE

METAL PLANT BOX

WOOD BENCH

FIREPIT

ITEM

PROPOSED TREE

PLANTING AREA

DESCRIPTION

Precast Concrete Paver from Stepstone, Inc.

over Clean Washed Drain Rock, Filter Fabric,

and Drainage Board on Roof Deck.

DESCRIPTION

Custom Aluminum Planter from Planterworx

IPE Wood Seat Surface Mounted to Metal

Concreteworks Hemi 60 Firepit, Electronic

Ignition, Color: Fog

DESCRIPTION

See Planting Plan

and Planting Details

See Planting Plan and Planting Details

1.00 PAVMENTS

SYMB.

SYMB.

2.00 WALLS, GATES, FENCES, MISC

NO.

NO.

2.03

3.00 PLANTING SYMBOL

+ **PA** +

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DETAIL

DETAIL

DETAIL



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LANDSCAPE MATERIALS

PLAN - LEVELS 6 & 7

PLAN



- For Building Details, See Arch Dwgs.
- For Utilities and Street Improvement Details, See Civil Dwgs.
- For Landscape Materials, See Landscape Material Plans.
- 4. For Planting Information, See Landscape Planting Plans.
- 6. "I have complied with the criteria of the ordinance and applied them for the efficient use of water in the landscape design plan".
- 7. "I agree to comply with, or cause anyone who works on the landscape design plan to comply with, the requirements of Chapter 15.11 of Title 15 of the San Jose Municipal Code and to submit a complete landscape design plan that complies with Chapter 15.11 of Title 15 of the San Jose Municipal Code."

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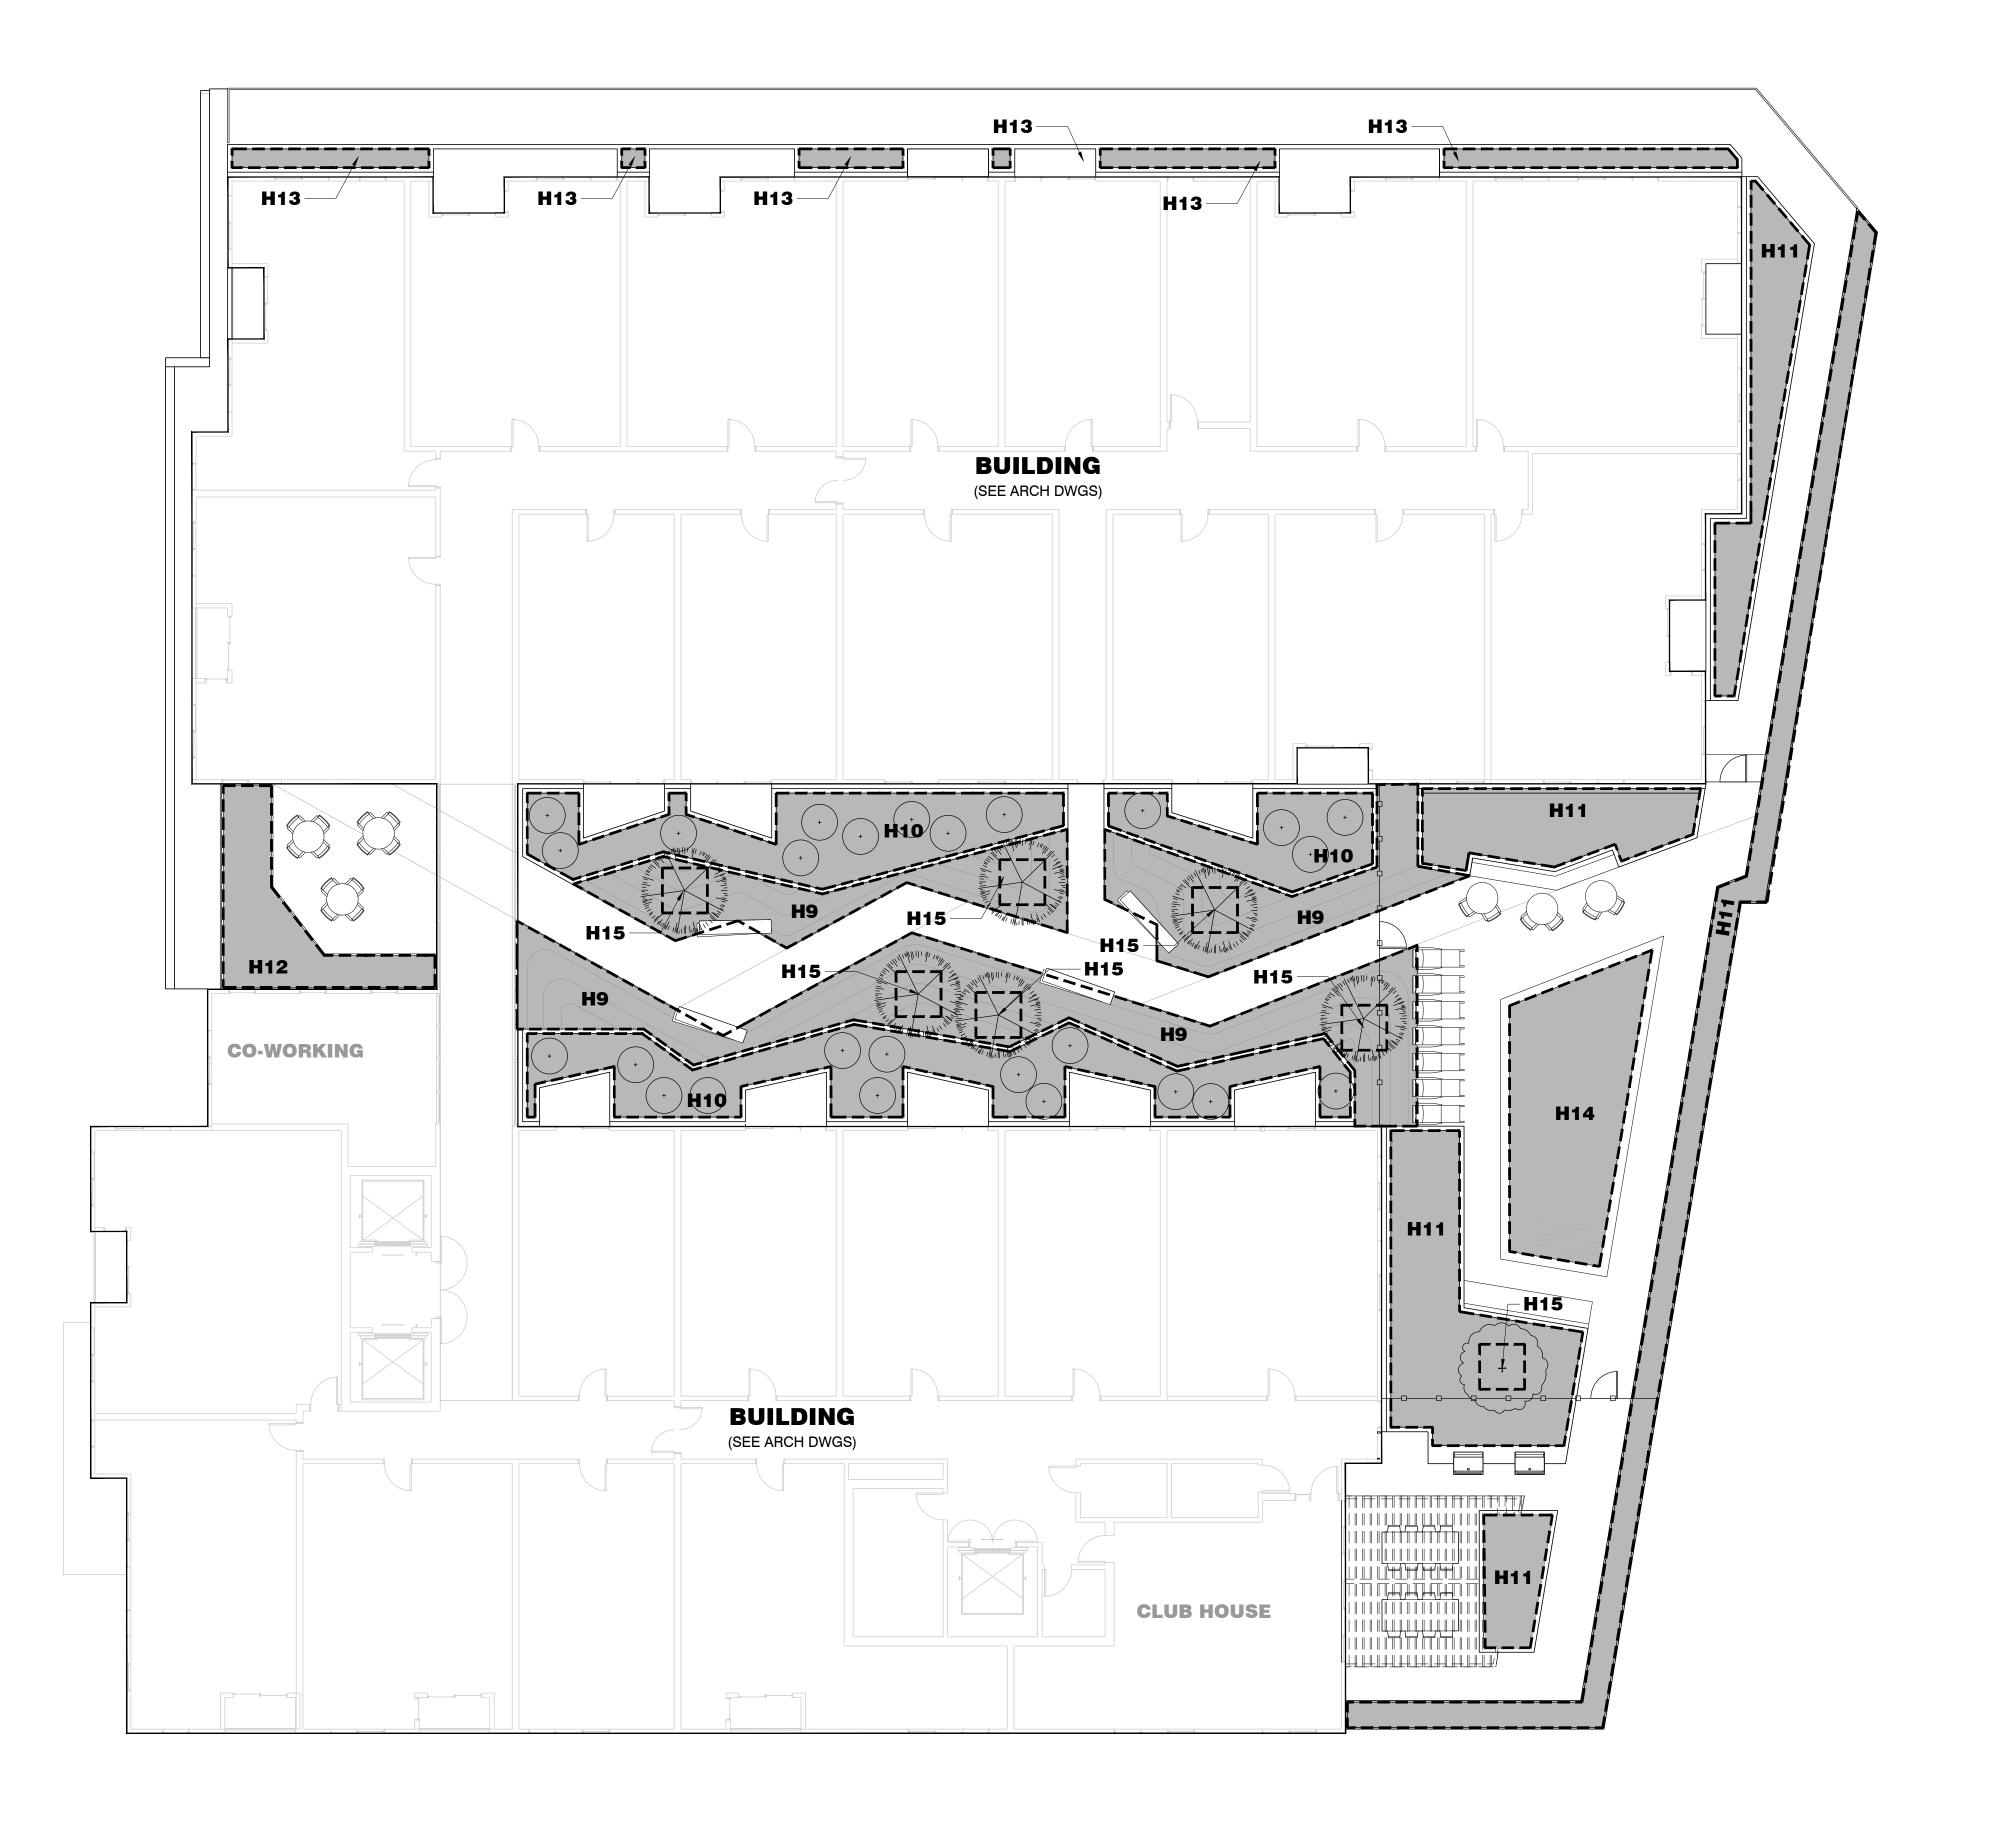


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HYDROZONE PLAN -GROUND LEVEL

027-L



3/32" = 1' - 0"

- For Building Details, See Arch Dwgs.
- For Utilities and Street Improvement Details, See Civil Dwgs.
- For Landscape Materials, See Landscape Material Plans.
- 4. For Planting Information, See Landscape Planting Plans.
- 6. "I have complied with the criteria of the ordinance and applied them for the efficient use of water in the landscape design plan".
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HYDROZONE PLAN -

LEVEL 3

028-L

BUILDING (SEE ARCH DWGS) H17-HYDROZONE PLAN - LEVEL 6 PLAN SECTION A: HYDROZONE INFORMATION TABLE Reference Evapotranspiration (ETo) = 45.30 San Jose ETWU Calculations Please complete the table below for each hydrozone or valve of the irrigation system. Regular Landscape Area Irrigation Method (B) | Irrigation Efficiency | ETAF (IE) (C)

NOTES:

- 1. For Building Details, See Arch Dwgs.
- 2. For Utilities and Street Improvement Details, See Civil Dwgs.
- 3. For Landscape Materials, See Landscape Material Plans.
- 4. For Planting Information, See Landscape Planting Plans.
- 7. "I agree to comply with, or cause anyone who works on the landscape design plan to comply with, the requirements of Chapter 15.11 of Title 15 of the San Jose Municipal Code and to submit a complete landscape design plan that complies with Chapter 15.11 of Title 15 of the San Jose Municipal Code."

SECTION B: WATER BUDGET CALCULATIONS

3/32" = 1' - 0"

Estimated Total Water

Use (ETWU) gallons per

137,780.66

H16

Water Saving Plant List

1177

1476

9,298.00 4,905.67

(LA) sq.ft.

	Average ETAF for All Landscape Areas	
0.53	0.53	Average ETAF for Regular Landscape Armust be 0.55 or below for residential areas and 0.45 or below for non-residential area
MAWA Calculations		
Maximum Applied Water Allowance (MAWA) =	(ETo)*(0.62)* ((ETAF*LA) + ((1-ETAF)*SLA	
		MAWA gallons per year
Where 0.62 is a conversion factor that converts acre-inche is the total landscape area in sq. ft.; SLA is the total species		LA
residential areas and 0.45 for non-residential areas.	an amostape area in our manufacture to 0.55 for	143,629.00
The ETo values for Santa Clara County are based		of
The ETo values for Santa Clara County are based Water Resources, through the California Irrigation program.		of
Water Resources, through the California Irrigation		of
Water Resources, through the California Irrigation program.		of
Water Resources, through the California Irrigation program. Comparison of ETWU and MAWA	n Management Information Systems (CIMIS)	Vater Allowance (MAWA) gallons per year
Water Resources, through the California Irrigation	ons per year Maximum Applied V	
Water Resources, through the California Irrigation program. Comparison of ETWU and MAWA Estimated Total Water Use (ETWU) gallo	ons per year Maximum Applied V	Vater Allowance (MAWA) gallons per year
Water Resources, through the California Irrigation program. Comparison of ETWU and MAWA Estimated Total Water Use (ETWU) gallot 137,780.66 In order to be in compliance with the	ons per year Maximum Applied V 143 Me Sustainable Landscape Ordina	Vater Allowance (MAWA) gallons per year 3,629.00 Ince, the project's ETWU gallons
Water Resources, through the California Irrigation program. Comparison of ETWU and MAWA Estimated Total Water Use (ETWU) gallot 137,780.66	ons per year Maximum Applied V 143 Me Sustainable Landscape Ordina	Vater Allowance (MAWA) gallons per years, 629.00 Ince, the project's ETWU gallo

PROJECT MEETS WATER EFFICIENCY REQUIREMENTS: ETWU IS LESS THAN MAWA



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HYDROZONE PLAN -LEVEL 6 & 7

HYDROZONE PLAN - LEVEL 7

PLAN

3/32" = 1' - 0"

BUILDING

(SEE ARCH DWGS)

Building Entry Planting

Willow St Sidewalk Trees

Kotenberg Sidewalk Trees

C.3. Flow Through Planters

Coworking Shade Garden

Northeast Terraces

Roof Top Planters

Roof Top Trees

Pool Plantings

Kotenberg Ave Sidewalk Planting

Palm Trees

NOT USED

0.4

0.5

0.5

0.1

0.3

0.4

0.4

0.5


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PLANTING PLAN - GROUND LEVEL

030-L

SHADE GARDEN, TYP. **BUILDING** (SEE ARCH DWGS) POOL GARDEN POOL GARDEN C.3 FLOW-THROUGH PLANTER SHADE GARDEN C.3 FLOW-THROUGH PLANTER **DUNE GARDEN** PRIVACY PLANTING **CO-WORKING** C.3 FLOW-THROUGH PLANTER DUNE GARDEN PG 2 PG PG **POOL GARDEN** 1 AU **BUILDING** (SEE ARCH DWGS) ║╴║╶╟╒╫═╢┍╫═┪╸╠═╫╕║╒╫═╢╴║ ║╴║┎╫╴╫╶╫╌╫╶╫╴╫╶╫═ **CLUB HOUSE** POOL GARDEN

NOTES:

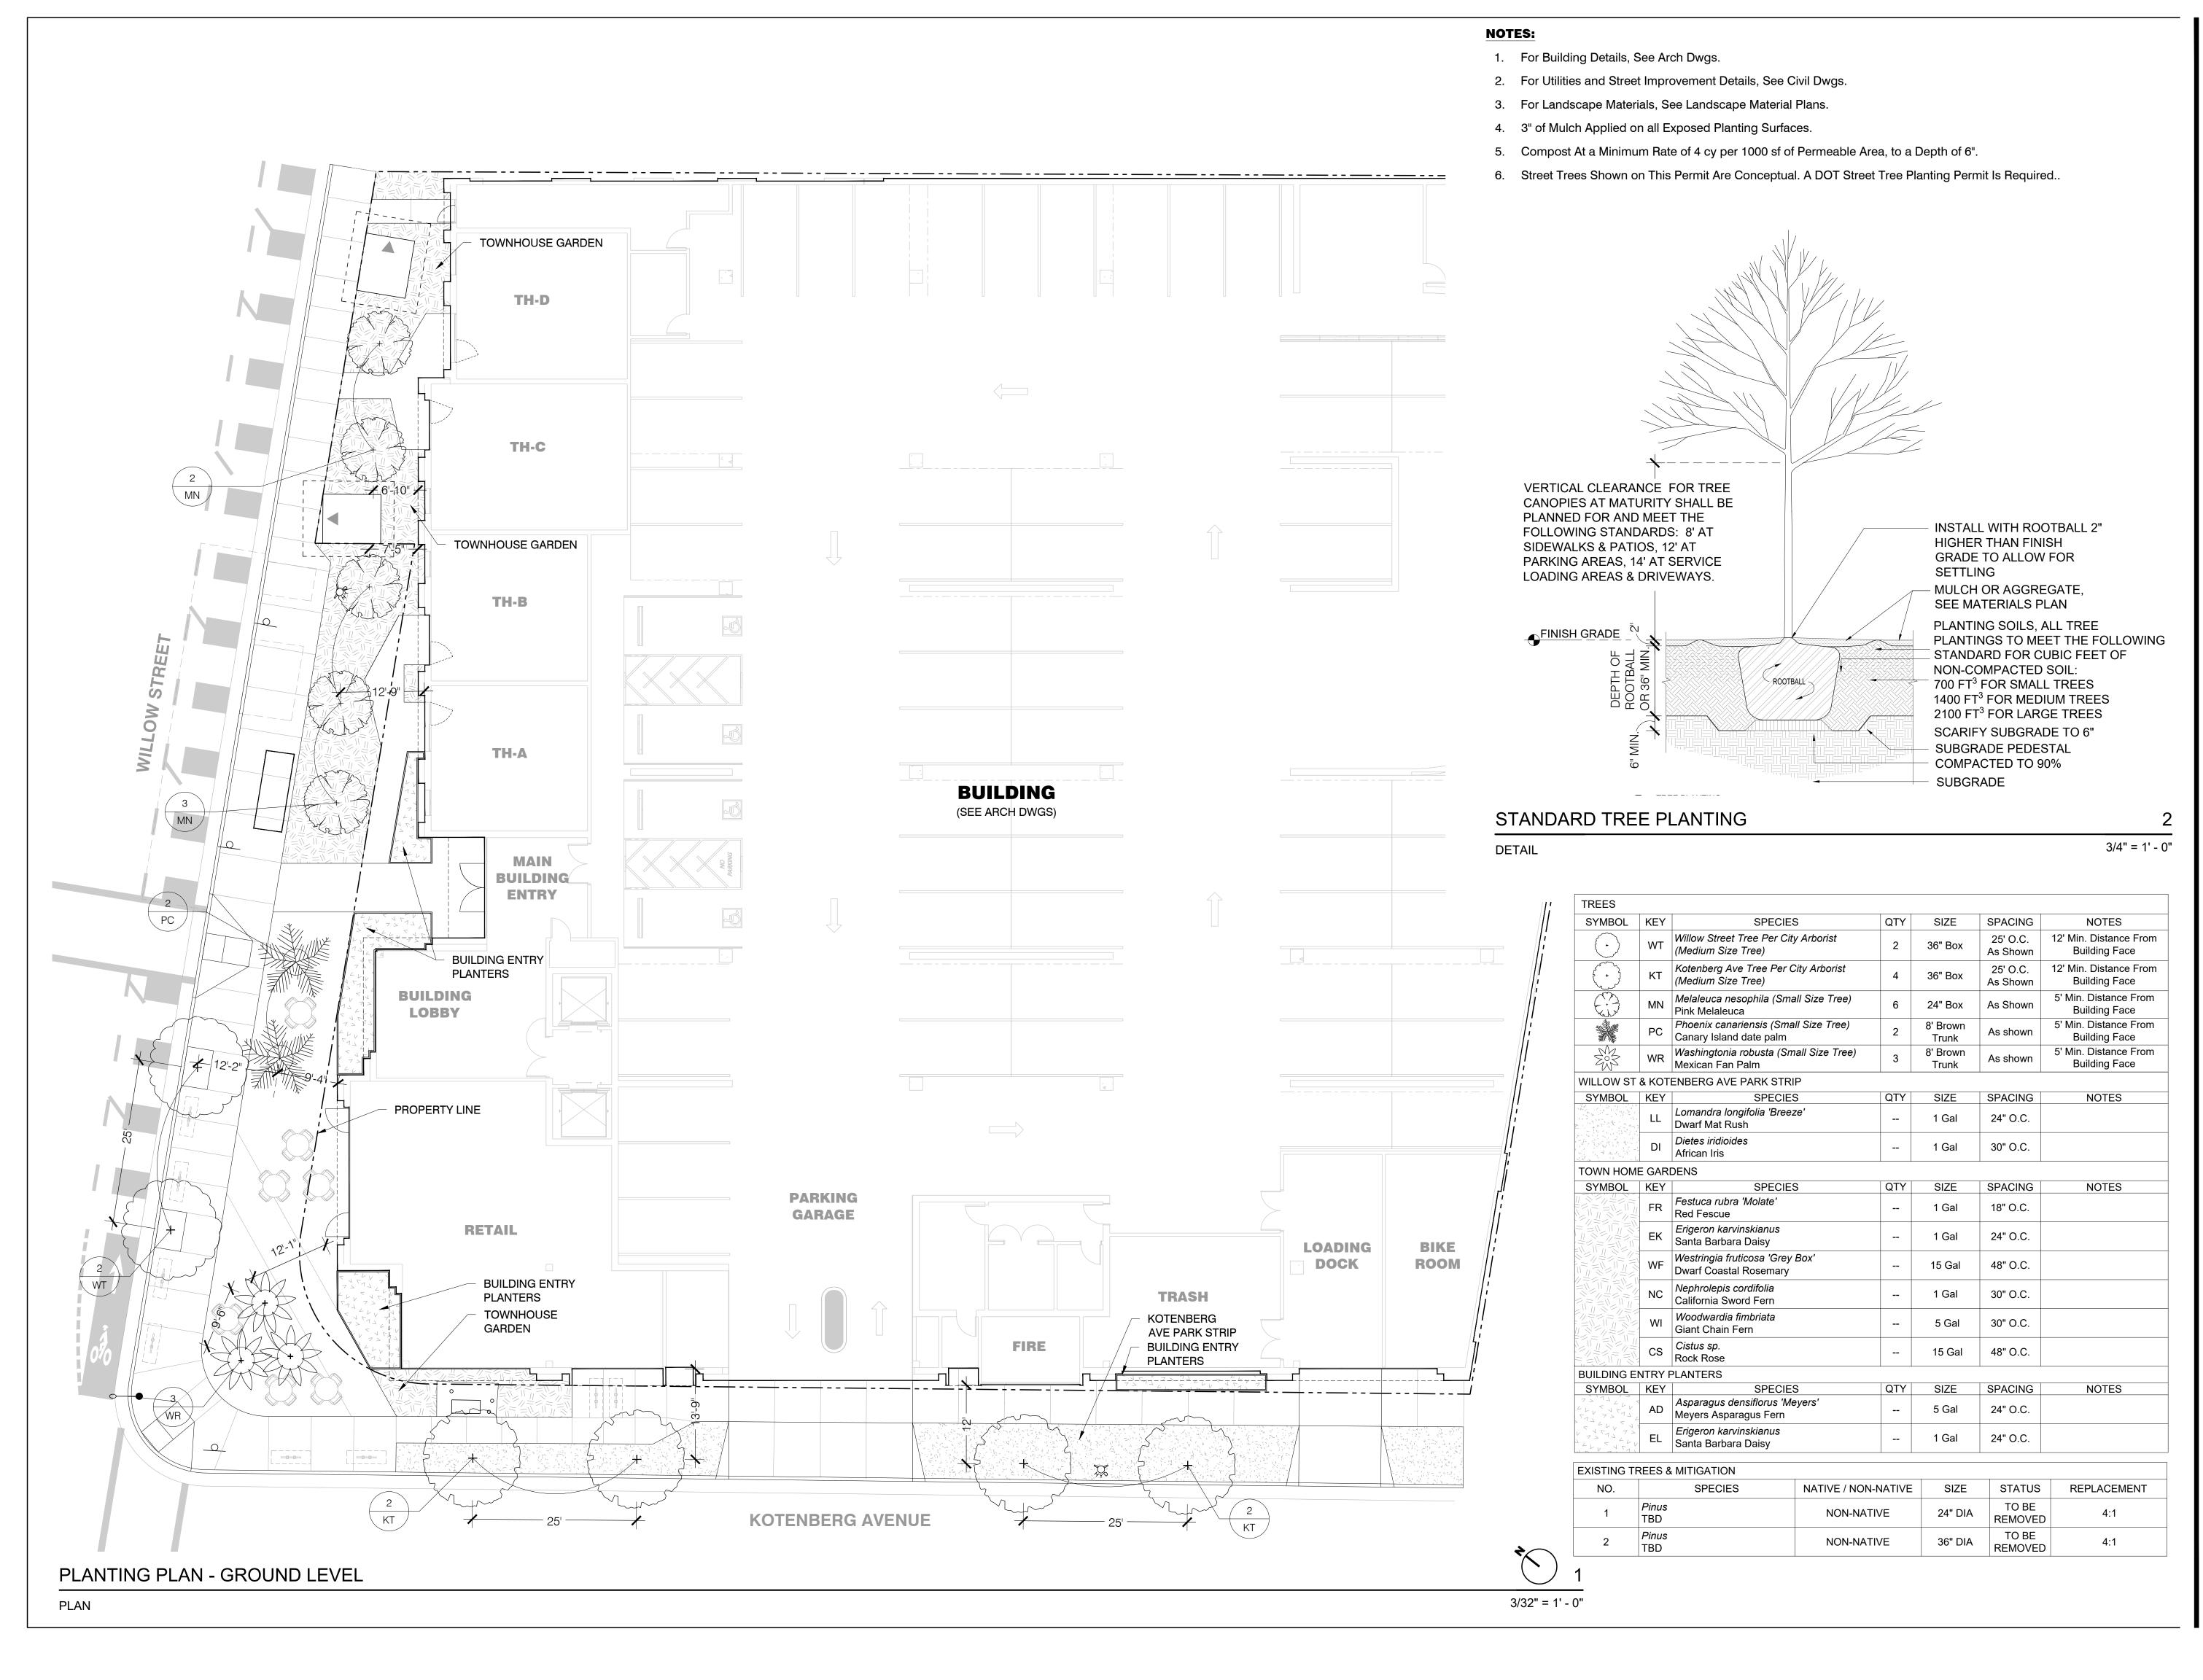- 1. For Building Details, See Arch Dwgs.
- 2. For Utilities and Street Improvement Details, See Civil Dwgs.
- 3. For Landscape Materials, See Landscape Material Plans.
- 4. 3" of Mulch Applied on All Exposed Planting Surfaces.
- 5. Compost at a Minimum Rate of 4 cy per 1000 sf of Permeable Area, to a Depth of 6".
- 6. "Provide a Minimum Soil Depth of 36 Inches and Soil Volume For Each

NOTES

Standard Tree Form

Multi-stem Form

NOTES

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Sheet Title	
Scale	3/32" = 1'
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Drawn	AS
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PLANTING PLAN -LEVEL 3

TREES

SYMBOL KEY

PODIUM PLANTING SYMBOL KEY

DUNE GARDENS

SHADE GARDEN

POOL GARDEN

PRIVACY PLANTING

SYMBOL KEY

SPECIES

SPECIES

Penstemon heterophyllus 'Margarita BOP'

LL Lomandra longifolia 'Platinum Beauty'
Platinum Beauty Dwarf Mat Rush

Podocarpus gracilior

PH Margarita BOP Penstemon

AS Adenanthos sericeus
Woolly Bush

EK Erigeron karvinskianus Santa Barbara Daisy

NC Nephrolepis cordifolia
California Sword Fern

WG Woodwardia fimbriata
Giant Chain Fern

NC Nephrolepis cordifolia California Sword Fern

WF Woodwardia fimbriata
Giant Chain Fern

Al Anigozanthos 'Big Red'
Big Red Kangaroo Paws

AB Anigozanthos 'Bush Dawn'
Yellow Kangaroo Paws

LV Leucaspermum 'Veldfire'

Veldfire Pincushion

C.3 FLOW THROUGH PLANTER - STORMWATER GARDEN

AC Verbena lilacina 'De La Mina' Cedros Island Verbena

AN Cape Rush

DC Guara lindheimeri 'Whirling Butterfly'
White Gaura

CS *Muhlenbergia rigens*Deer Grass

CA *Iris douglasiana* Douglas Iris

CP Heuchera maxima Island Alum Root

LS Leucadendron 'Safari Sunset'
Safari Sunset Leucadendron

LL Lomandra longifolia 'Platinum Beauty'
Platinum Beauty Dwarf Mat Rush

AH Agave shawii x attenuata 'Blue Flame' Agave 'Blue Flame'

PT Pittosporum tenuifolium 'Silver Sheen' Silver Sheen Kohuhu

SPECIES

AA Arctostaphylos densiflora 'Howard McMinn' Howard McMinn Manzanita

CM Clivia miniata
Bush Lily

Arbutus unedo AU Dwarf Strawberry Tree

PG Fern Pine

QTY

SIZE

1 36" Box

QTY

SPACING

As Shown

As Shown

1 or 5 Gal 15" O.C.

1 or 5 Gal 15" O.C.

1 or 5 Gal 12" O.C.

1 or 5 Gal 30" O.C.

-- 1 or 5 Gal 30" O.C.

-- 1 or 5 Gal 15" O.C.

-- 1 or 5 Gal 30" O.C.

-- 1 or 5 Gal 30" O.C.

1 or 5 Gal 15" O.C.

1 or 5 Gal 30" O.C.

30" O.C.

5' O.C.

5' O.C.

5' O.C.

36" O.C.

SPACING

5' O.C.

30" O.C.

15" O.C.

30" O.C.

15" O.C.

NOTES

All Species Approved for Flow-Through Planter

Treatement Type in Santa

Clara County C.3

Guidelines

1 or 5 Gal

15 Gal

15 Gal

15 Gal

15 Gal

SIZE

15 Gal

5 Gal

1 or 5 Gal

1 or 5 Gal

1 or 5 Gal

1 or 5 Gal 15" O.C.

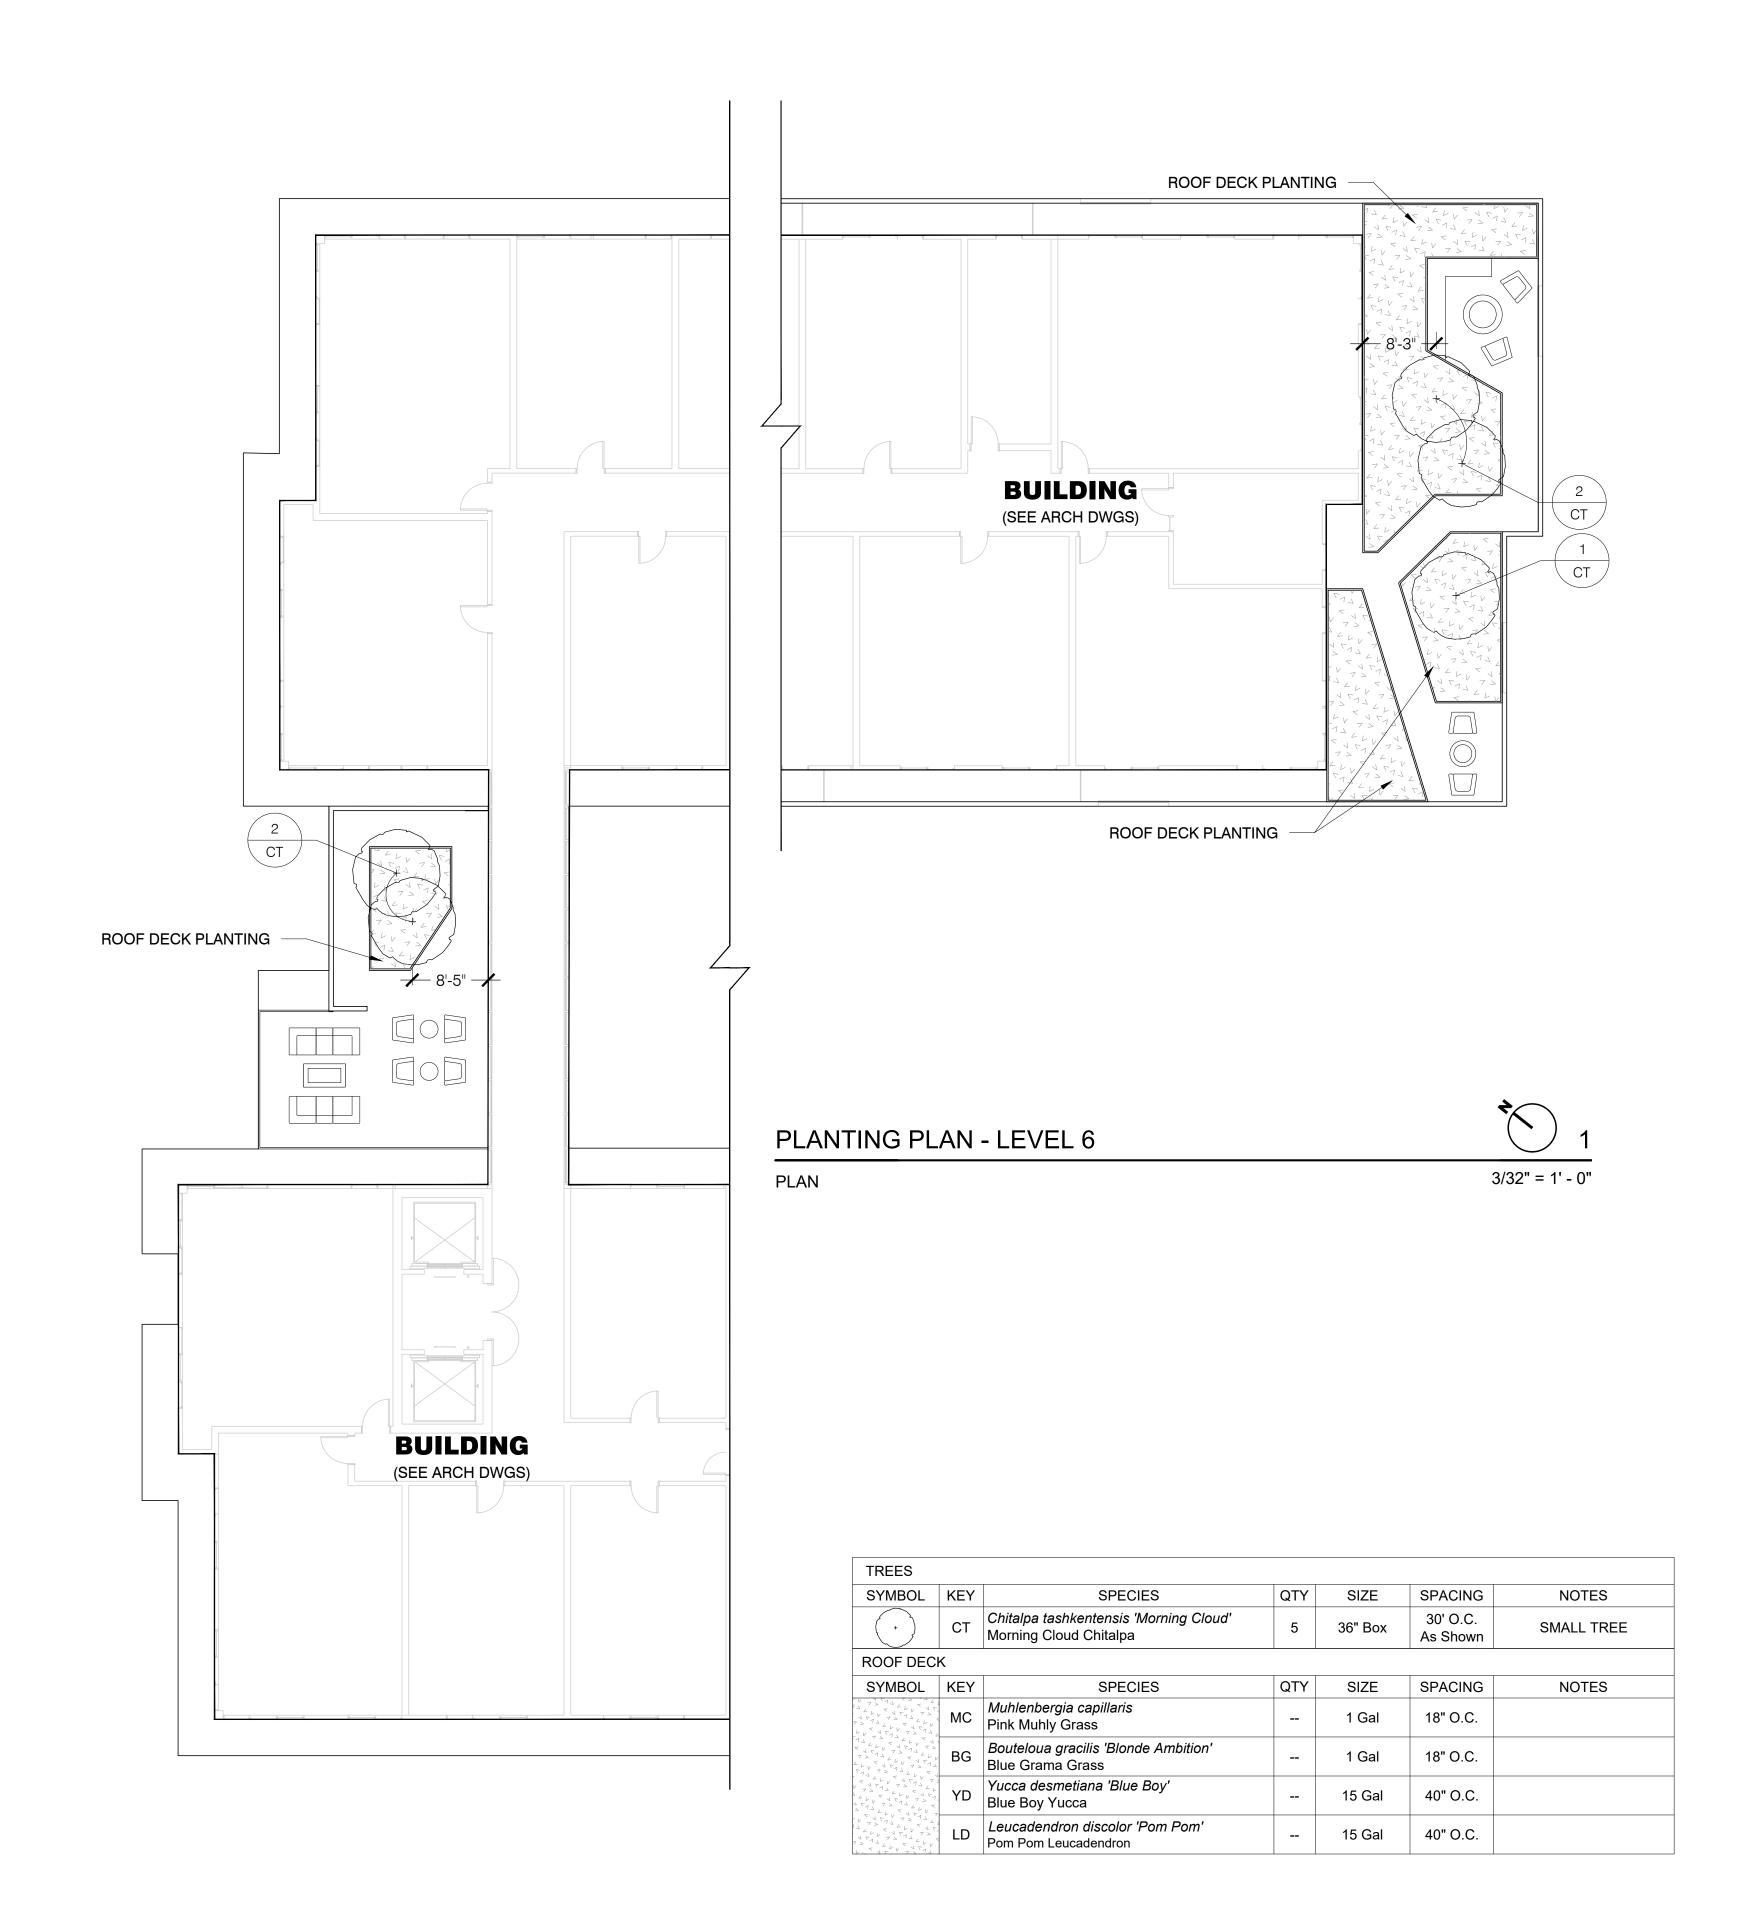
1 or 5 Gal 30" O.C.

SPACING

5' O.C.

SIZE

15 Gal



- 1. For Building Details, See Arch Dwgs.
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- 3. For Landscape Materials, See Landscape Material Plans.
- 4. 3" of mulch applied on all exposed planting surfaces.
- 5. Compost at a minimum rate of 4 cy per 1000 sf of permeable area, to a depth of 6".
- 6. "Provide a minimum soil depth of 36 inches and soil volume for each tree".



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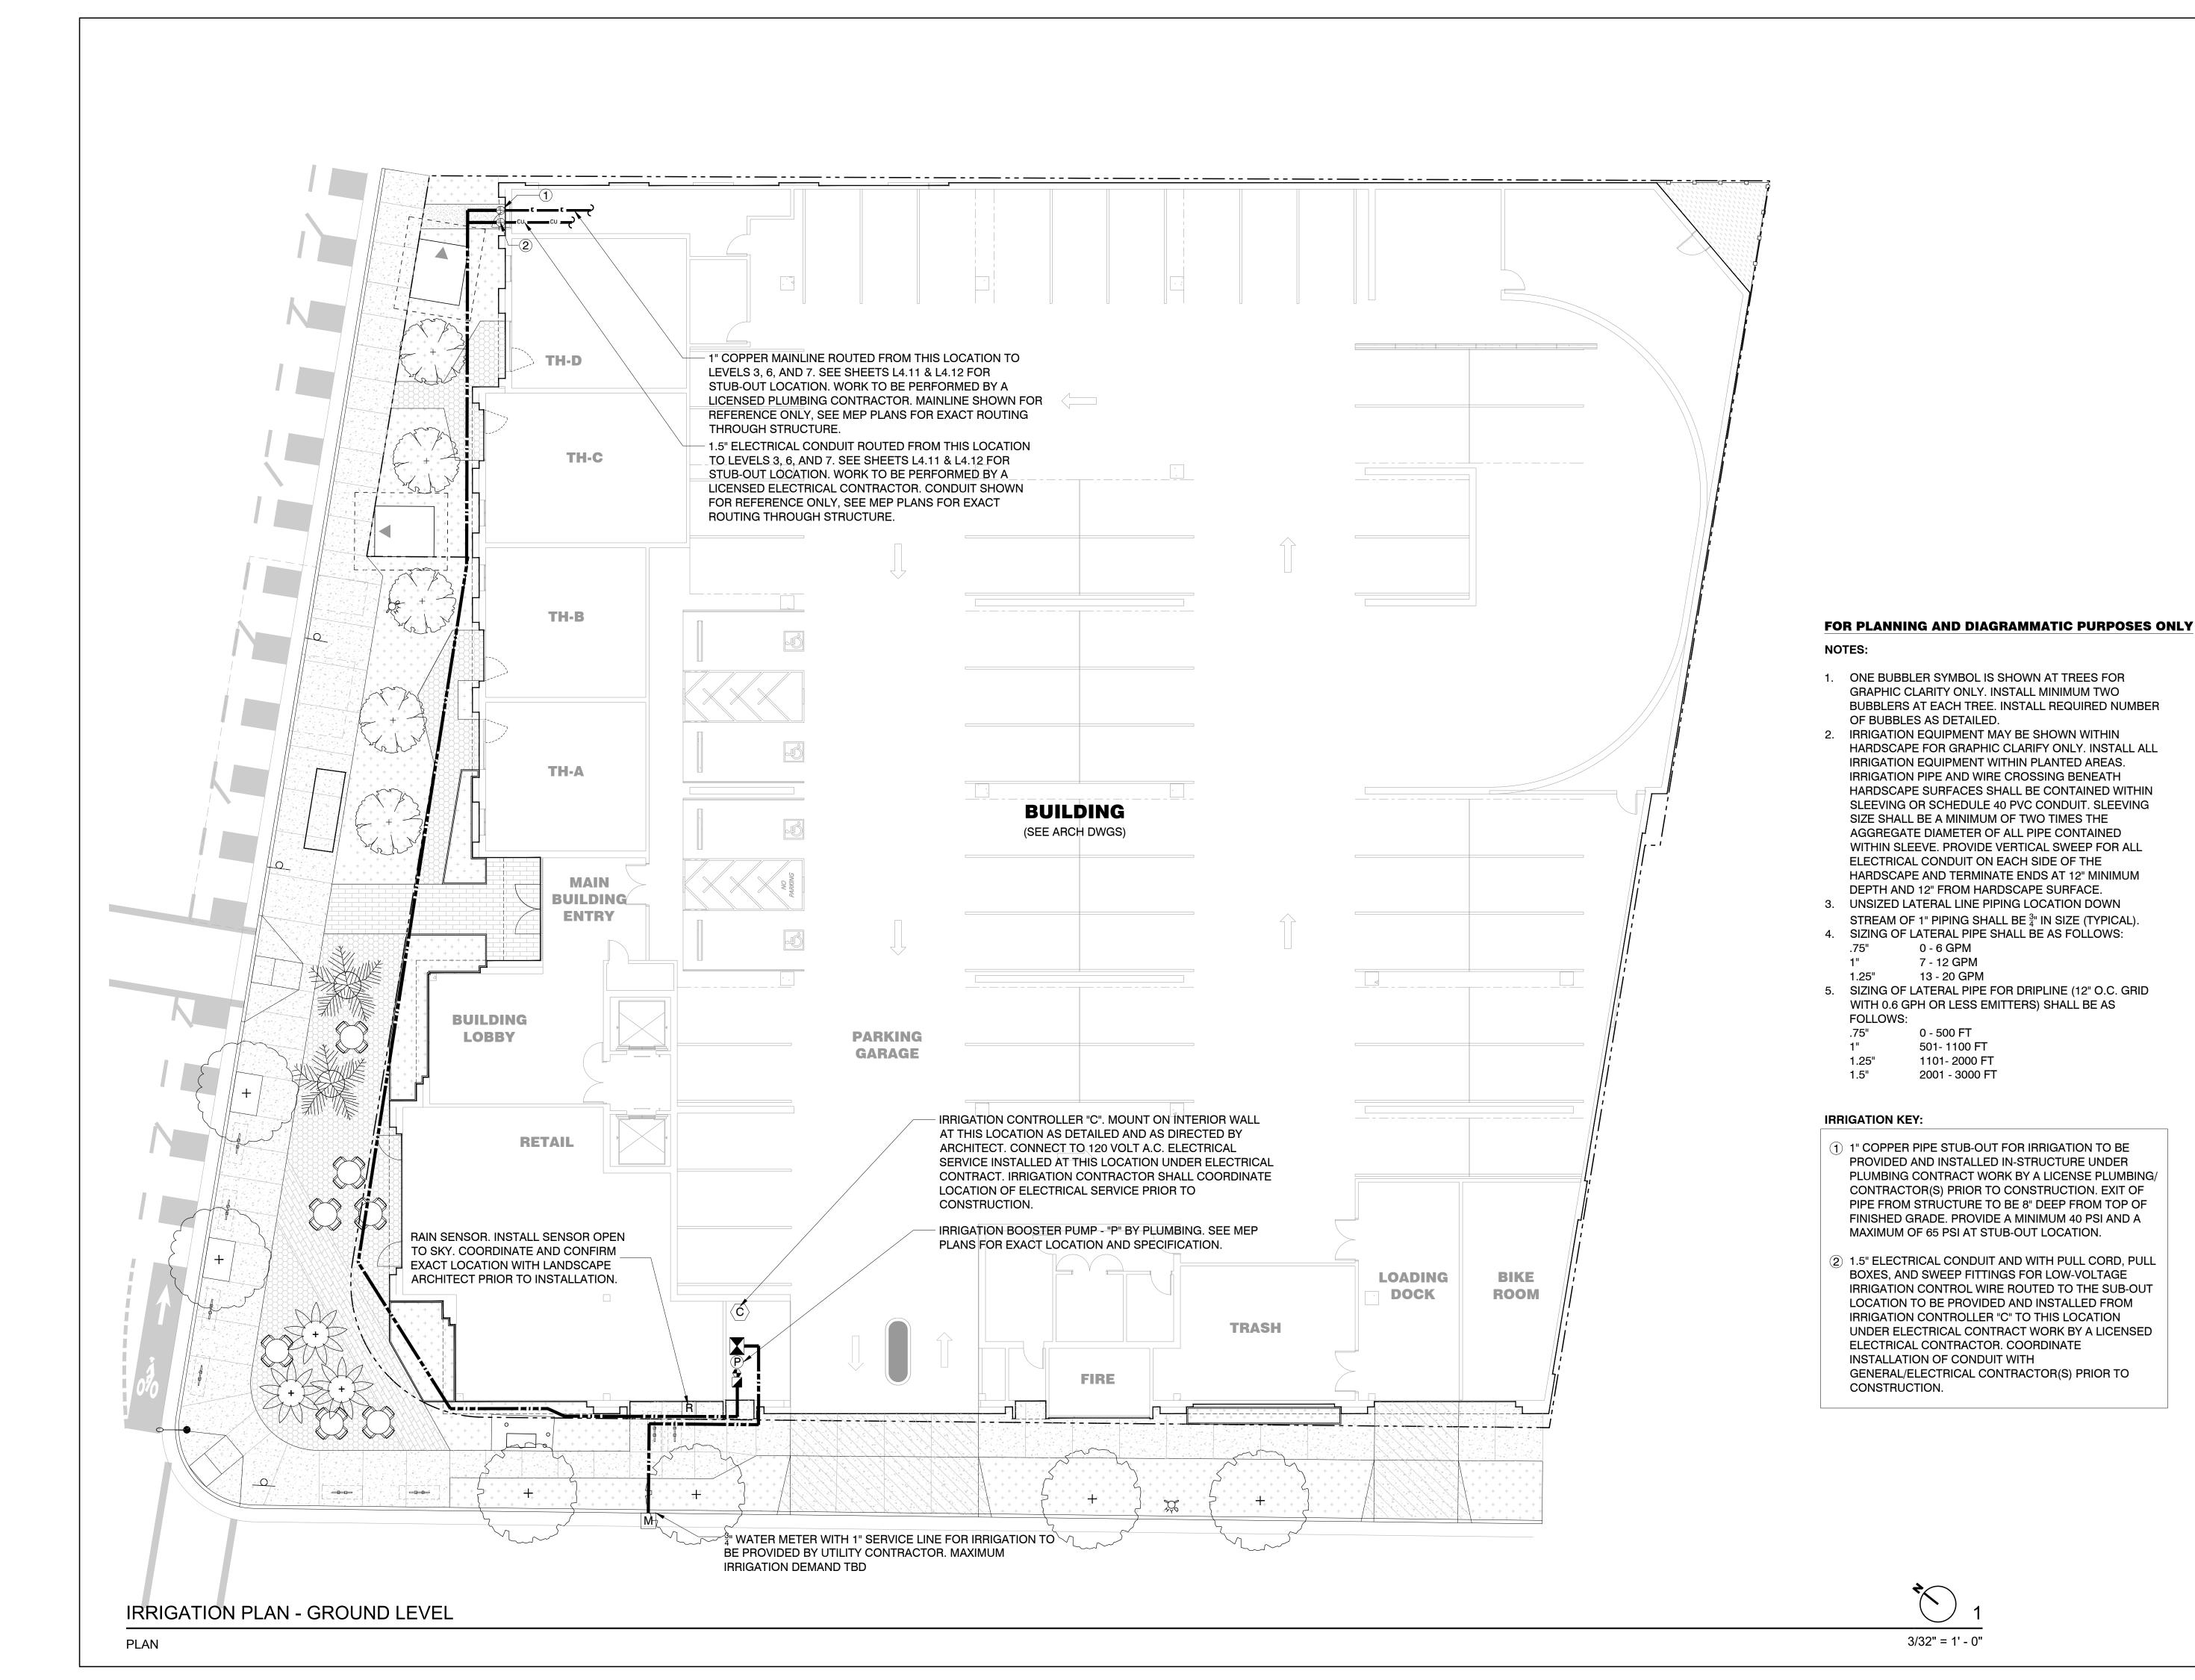
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PLANTING PLAN -

LEVELS 6 & 7

PLAN

PLANTING PLAN - LEVEL 7





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0 - 6 GPM

7 - 12 GPM

13 - 20 GPM

0 - 500 FT

501- 1100 FT

1101- 2000 FT

2001 - 3000 FT

SITE DEVELOPMENT 10.05.2023 12.01.2023


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Sheet Information

Sheet Title	
Scale	3/32" = 1'-0"
Approved	MA
Checked	MA
Drawn	AS
Job Number	230801
Issue Date	12/01/23

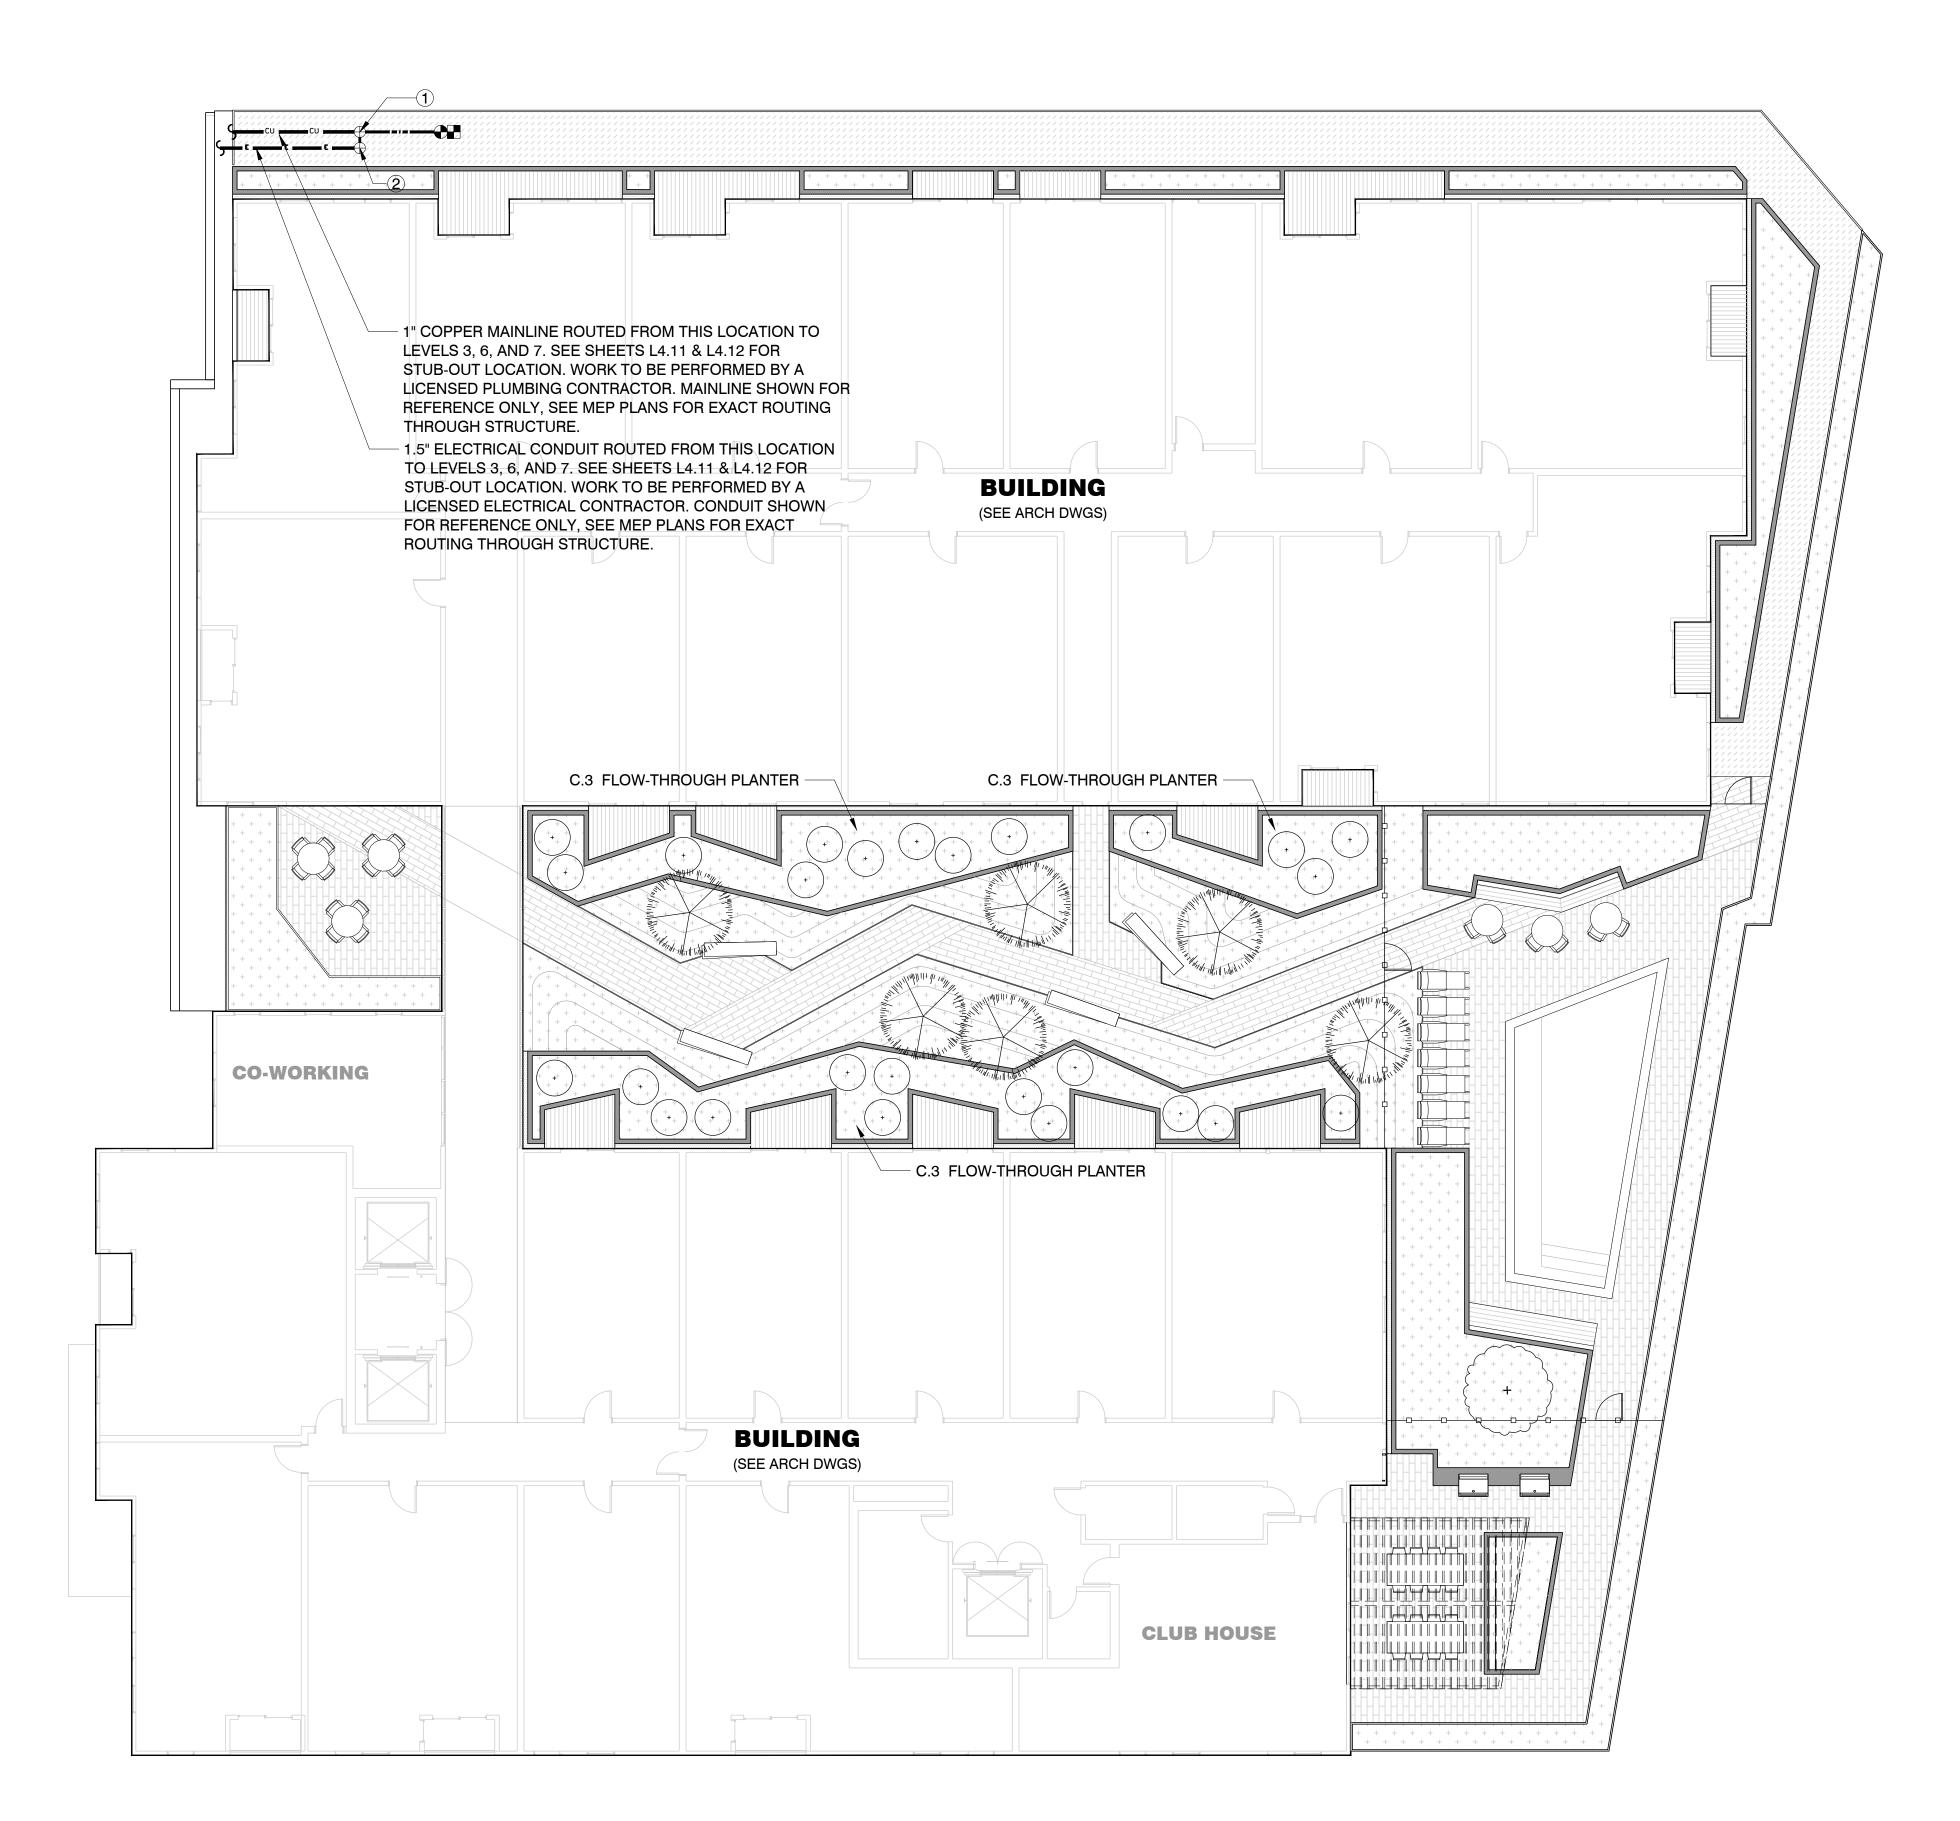IRRIGATION PLAN -GROUND LEVEL





940 Willow Street

Mixed Use Proposal

Consultant SAW

H23-030 SITE DEVELOPMENT **PERMIT**

Revision

No	Date
SITE DEVELOPMENT	10.05.2023
REVISION 1	12.01.2023

Stamp



Sheet Information

Sheet Title	
Scale	3/32" = 1'-
Approved	MA
Checked	MA
Drawn	AS
Job Number	23080
Issue Date	12/01/2

IRRIGATION PLAN -LEVEL THREE

FOR PLANNING AND DIAGRAMMATIC PURPOSES ONLY

NOTES:

- 1. ONE BUBBLER SYMBOL IS SHOWN AT TREES FOR GRAPHIC CLARITY ONLY. INSTALL MINIMUM TWO BUBBLERS AT EACH TREE. INSTALL REQUIRED NUMBER OF BUBBLES AS DETAILED.
- 2. IRRIGATION EQUIPMENT MAY BE SHOWN WITHIN HARDSCAPE FOR GRAPHIC CLARIFY ONLY. INSTALL ALL IRRIGATION EQUIPMENT WITHIN PLANTED AREAS. IRRIGATION PIPE AND WIRE CROSSING BENEATH HARDSCAPE SURFACES SHALL BE CONTAINED WITHIN SLEEVING OR SCHEDULE 40 PVC CONDUIT. SLEEVING SIZE SHALL BE A MINIMUM OF TWO TIMES THE AGGREGATE DIAMETER OF ALL PIPE CONTAINED WITHIN SLEEVE. PROVIDE VERTICAL SWEEP FOR ALL ELECTRICAL CONDUIT ON EACH SIDE OF THE HARDSCAPE AND TERMINATE ENDS AT 12" MINIMUM
- DEPTH AND 12" FROM HARDSCAPE SURFACE. 3. UNSIZED LATERAL LINE PIPING LOCATION DOWN
- STREAM OF 1" PIPING SHALL BE $\frac{3}{4}$ " IN SIZE (TYPICAL). 4. SIZING OF LATERAL PIPE SHALL BE AS FOLLOWS:

.75" 0 - 6 GPM 7 - 12 GPM 1.25" 13 - 20 GPM

5. SIZING OF LATERAL PIPE FOR DRIPLINE (12" O.C. GRID WITH 0.6 GPH OR LESS EMITTERS) SHALL BE AS FOLLOWS:

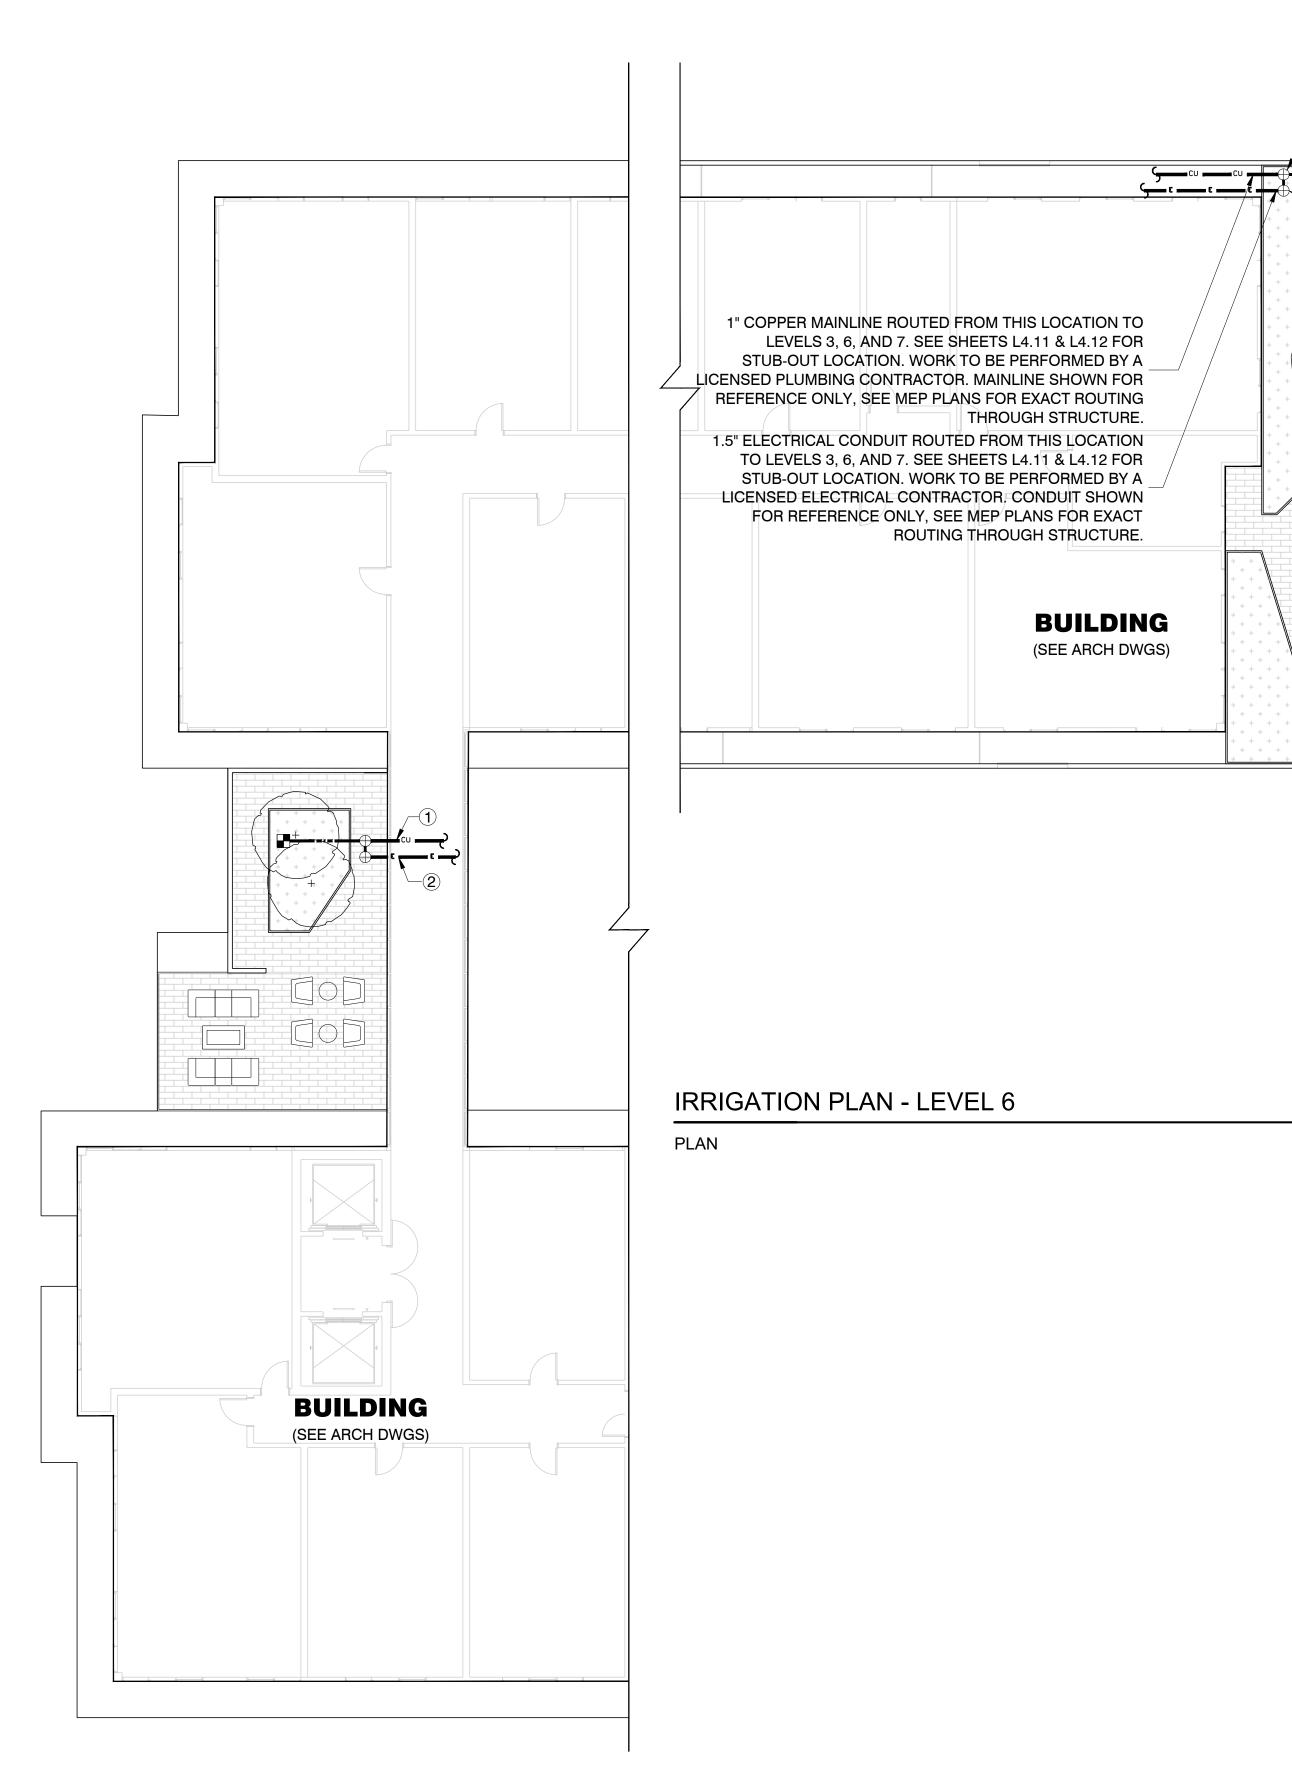
0 - 500 FT .75" 501- 1100 FT 1.25" 1101- 2000 FT 1.5" 2001 - 3000 FT

IRRIGATION KEY:

- (1) 1" COPPER PIPE STUB-OUT FOR IRRIGATION TO BE PROVIDED AND INSTALLED IN-STRUCTURE UNDER PLUMBING CONTRACT WORK BY A LICENSE PLUMBING/ CONTRACTOR(S) PRIOR TO CONSTRUCTION. EXIT OF PIPE FROM STRUCTURE TO BE 8" DEEP FROM TOP OF FINISHED GRADE. PROVIDE A MINIMUM 40 PSI AND A MAXIMUM OF 65 PSI AT STUB-OUT LOCATION.
- (2) 1.5" ELECTRICAL CONDUIT AND WITH PULL CORD, PULL BOXES, AND SWEEP FITTINGS FOR LOW-VOLTAGE IRRIGATION CONTROL WIRE ROUTED TO THE SUB-OUT LOCATION TO BE PROVIDED AND INSTALLED FROM IRRIGATION CONTROLLER "C" TO THIS LOCATION UNDER ELECTRICAL CONTRACT WORK BY A LICENSED ELECTRICAL CONTRACTOR. COORDINATE INSTALLATION OF CONDUIT WITH GENERAL/ELECTRICAL CONTRACTOR(S) PRIOR TO CONSTRUCTION.

IRRIGATION PLAN - LEVEL 3

3/32" = 1' - 0"





940 Willow Street

Mixed Use Proposal

Consultant SAW

FOR PLANNING AND DIAGRAMMATIC PURPOSES ONLY

NOTES:

- 1. ONE BUBBLER SYMBOL IS SHOWN AT TREES FOR GRAPHIC CLARITY ONLY. INSTALL MINIMUM TWO BUBBLERS AT EACH TREE. INSTALL REQUIRED NUMBER OF BUBBLES AS DETAILED.
- 2. IRRIGATION EQUIPMENT MAY BE SHOWN WITHIN HARDSCAPE FOR GRAPHIC CLARIFY ONLY. INSTALL ALL IRRIGATION EQUIPMENT WITHIN PLANTED AREAS. IRRIGATION PIPE AND WIRE CROSSING BENEATH HARDSCAPE SURFACES SHALL BE CONTAINED WITHIN SLEEVING OR SCHEDULE 40 PVC CONDUIT. SLEEVING SIZE SHALL BE A MINIMUM OF TWO TIMES THE AGGREGATE DIAMETER OF ALL PIPE CONTAINED WITHIN SLEEVE. PROVIDE VERTICAL SWEEP FOR ALL ELECTRICAL CONDUIT ON EACH SIDE OF THE HARDSCAPE AND TERMINATE ENDS AT 12" MINIMUM DEPTH AND 12" FROM HARDSCAPE SURFACE.
- 3. UNSIZED LATERAL LINE PIPING LOCATION DOWN STREAM OF 1" PIPING SHALL BE $\frac{3}{4}$ " IN SIZE (TYPICAL). 4. SIZING OF LATERAL PIPE SHALL BE AS FOLLOWS:
- .75" 0 - 6 GPM 7 - 12 GPM

1.25" 13 - 20 GPM

5. SIZING OF LATERAL PIPE FOR DRIPLINE (12" O.C. GRID WITH 0.6 GPH OR LESS EMITTERS) SHALL BE AS FOLLOWS:

.75" 0 - 500 FT 501- 1100 FT 1.25" 1101- 2000 FT 1.5" 2001 - 3000 FT

IRRIGATION KEY:

3/32" = 1' - 0"


- 1 1" COPPER PIPE STUB-OUT FOR IRRIGATION TO BE PROVIDED AND INSTALLED IN-STRUCTURE UNDER PLUMBING CONTRACT WORK BY A LICENSE PLUMBING/ CONTRACTOR(S) PRIOR TO CONSTRUCTION. EXIT OF PIPE FROM STRUCTURE TO BE 8" DEEP FROM TOP OF FINISHED GRADE. PROVIDE A MINIMUM 40 PSI AND A MAXIMUM OF 65 PSI AT STUB-OUT LOCATION.
- (2) 1.5" ELECTRICAL CONDUIT AND WITH PULL CORD, PULL BOXES, AND SWEEP FITTINGS FOR LOW-VOLTAGE IRRIGATION CONTROL WIRE ROUTED TO THE SUB-OUT LOCATION TO BE PROVIDED AND INSTALLED FROM IRRIGATION CONTROLLER "C" TO THIS LOCATION UNDER ELECTRICAL CONTRACT WORK BY A LICENSED ELECTRICAL CONTRACTOR. COORDINATE INSTALLATION OF CONDUIT WITH GENERAL/ELECTRICAL CONTRACTOR(S) PRIOR TO CONSTRUCTION.

H23-030 SITE DEVELOPMENT **PERMIT**

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IRRIGATION PLAN -

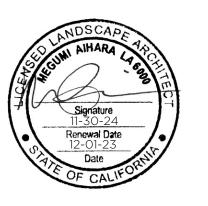LEVELS 6 & 7